
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# SPANISH FORK ARMORY PARKING IMPROVEMENTS PRELIMINARY PLANS

# SPANISH FORK, UTAH AUGUST 24, 2007

Project Number: 186302014

**UTAH NATIONAL GUARD** C/O D. SCOTT POTTER 12953 SOUTH MINUTEMAN DRIVE PO BOX 1776 DRAPER, UTAH 84020-1776 DFCM Project no.07263470 / HFSA #0747.01

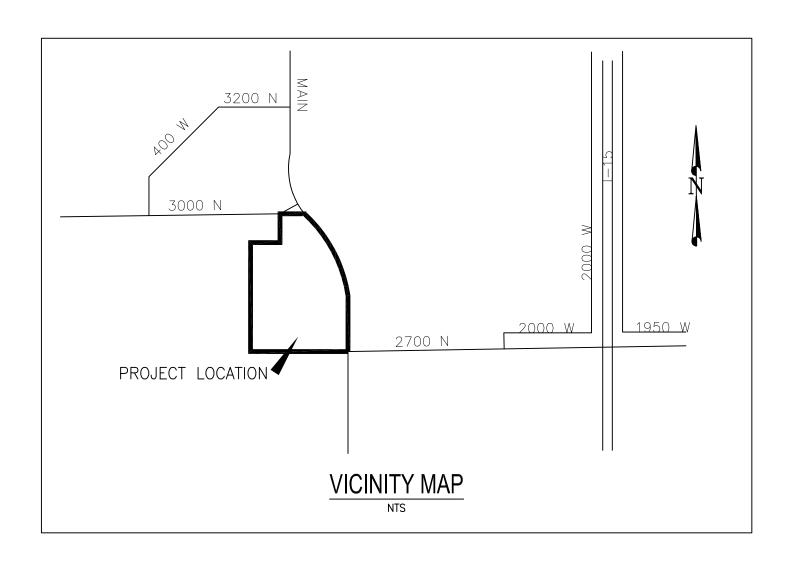



	APPLICAB	LE CODES		
	Year			Year
International Building Co	ode 2006	National Electrical Co	ode	2006
International Mechanical				
International Plumbing C	Code2006	Building Conservation	า	2006
International Fire Code	2006			
International Energy	2006	Guildelines		2003
Conservation Code	2006			
. Occupancy and Grou	ip: <u>S-1</u>			
Change in Use: Yes	No <u>X</u>	Mixed Occupancy: Yes _	1	No <u>X</u>
Special Use and Occ	upancy (e.g. High	n Rise, Covered Mall):	NO	
Seismic Design Categ	aorv:	Design Wind Speed:	mpl	h
Type of Construction		<u> </u>		
	,			
$\frac{I}{\Lambda}$ $\frac{I}{B}$	$\frac{\mathbf{I}}{\Lambda}$ $\frac{\mathbf{I}}{\Omega}$	$\underline{\underline{\mathbf{II}}}$ $\underline{\underline{\mathbf{II}}}$ $\underline{\underline{\mathbf{IV}}}$ $\underline{\underline{\mathbf{V}}}$	- ( <u>\frac{\fir}}}}}}{\frac{\frac{\frac{\frac{\frac{\frac{\frac{\frac{\frac{\frac{\frac{\frac{\frac{\frac{\frac{\frac{\frac{\frac{\frac{\fir}}}}}{\frac{\frac{\frac{\frac{\frac{\frac{\frac{\frac{\frac{\fir}}}}{\firac{\frac{\frac{\frac{\fig}}}}}{\firac{\frac{\f{\firi}}}}}{\firac{\frac{\frac{\frac{\fir}{\firac{\f{\fir}}}}}}{\f</u>	$\left(\frac{I}{2}\right)$
	-	–		
	•	s for the Exterior Walls base	d on the	e fire
separation distance (i	*	0 Mastr 0		
		<u>-0-</u> West: <u>-0-</u>		
Mixed Occupancies:	NONE No	nseparated Uses: <u>NO</u>		
Sprinklers:				
Required: NO	Provided: NO	_ Type of Sprinkler System	:	
Number of Stories:	1 Building	g Height: <u>13'-</u> 9"		
Actual Area per Floc		-		
Tabular Area: 9,0		·		
	10 OI			
Area Modifications:	7 - 7	-	7	
a) $\Delta = \Delta + \frac{A_t I_f}{A_t}$	$A_t I_s$	$I_f = 100 \left  \frac{F}{P} - 0.2 \right $	$_{5} \underline{W}$	
<sup>37</sup> /(a /(t <sup>-1</sup>   100	100	1, 100 P	30	
b) Sum of the Ratio	Calculations for '	Mixed Occupancies:	_	
Actual Area		wiixou Cooapariolos.		
	≤ 1			
Allowable Area				
c) Total Allowable A				
1) One Story:				
2) Two Story: A	A <sub>a</sub> (2)			
<ol><li>Three Story:</li></ol>	A <sub>a</sub> (3)			
d) Unlimited Area B	uilding: Yes	No X Code S	Section:	
Fire Resistance Rati	ng Requirements	for Building Elements (hour	s).	
		<u> </u>	,	A = = = - ! !
Element	Hours Assembly Listing	Element	Hours	Assembly Listing
Exterior Rearing Walls	N/A	Floors - Ceiling Floors	N/A	Liberity
Exterior Bearing Walls Interior Bearing Walls	N/A	Roofs - Ceiling Floors Roofs - Ceiling Roofs	N/A	
Exterior Non-Bearing Walls	N/A	Exterior Doors and Windows	N/A	
Structural Frame	N/A	Shaft Enclosures	N/A	
Partitions - Permanent Fire Barriers	N/A N/A	Fire Walls Fire Partitions	N/A N/A	
ı iie Dallielə		Smoke Partitions		
	N/A		N/A	
Design Occupant Loa				
Exit Width Required:	E	Exit Width Provided: 3 <u>'-0" Mll</u>	<u>V</u> .	
. Minimum Number of	Required Plumbi	ng Facilities:		
a) Water Closets - F	Required (m)	(f) Provided (m		
b) Lavatories - Red	quired (m)	(f) Provided (m)		
c) Bath Tubs or Sho	owers: <u>- 0 -</u>			
d) Drinking Fountair	าร: S	Service Sinks:		
DOTNOTES:	thalle Danaria	ent of Justice Endered Basis	etere De	rte T
		nent of Justice Federal Regis c reference to the Internatior		
		c reference to the internation estrictive requirement shall ç		ıı ıy
_			-	. ~
Additional Code Inform Official for Complex Bu		ovided at the discretion of the	e Buildin	g
•	0	, but not innited to.		
a) High Rise Requir	ements.			
b) Atriums.				
c) Performance Bas				
d) Means or Egress				
e) Fire Assembly Lo				
f) Exterior and Interi	ior Accessibility F	Route.		
a) Fire Stopping Inc	alcodina Talaka d. D.	esian Number		

g) Fire Stopping, Including Tested Design Number

FOLLOWING: THE INTERNATIONAL PLUMBING CODE, UTAH DRINKING WATER REGULATIONS, APWA MANUAL OF STANDARD PLANS AND SPECIFICATIONS AND SLC PUBLIC UTILITIES MODIFICATIONS TO APWA STANDARD PLANS AND APPROVED MATERIALS AND SPANISH FORK PUBLIC UTILITIES APWA SPECIFICATIONS MODIFICATIONS. THE CONTRACTOR IS REQUIRED TO ADHERE TO ALL OF THE ABOVE-MENTIONED DOCUMENTS UNLESS OTHERWISE NOTED AND APPROVED IN WRITING BY THE OWNERS REPRESENTATIVE.

THE CONTRACTOR IS RESPONSIBLE TO NOTIFY ALL APPROPRIATE GOVERNMENT AND PRIVATE ENTITIES ASSOCIATED WITH THE PROJECT. ALL APPROPRIATE GOVERNMENT AND PRIVATE ENTITIES MUST BE CONTACTED 48 HOURS PRIOR TO CONSTRUCTION AS APPLICABLE TO THE PROJECT.

#### PRIOR TO CONSTRUCTION THE CONTRACTOR WILL PROVIDE, AND WILL UPDATE AS CHANGES OCCUR, A CONSTRUCTION SCHEDULE IN ACCORDANCE

WITH THE SPECIFICATIONS AND CITY OR COUNTY REGULATIONS AS APPLICABLE FOR WORKING IN THE PUBLIC WAY.

CONTRACTOR MUST OBTAIN ALL THE NECESSARY PERMITS AND AGREEMENTS AND PAY ALL APPLICABLE FEES PRIOR TO ANY CONSTRUCTION ACTIVITIES. APPLICABLE UTILITY PERMITS MAY INCLUDE MAINLINE EXTENSION AGREEMENTS AND SERVICE CONNECTION PERMITS. ALL UTILITY WORK

CONSTRUCTION SITES MUST BE IN COMPLIANCE WITH THE UTAH POLLUTION DISCHARGE ELIMINATION SYSTEM (UPDES) STORM WATER PERMIT FOR CONSTRUCTION ACTIVITIES. A COPY OF THE PERMIT'S STORM WATER POLLUTION PREVENTION PLAN MUST BE SUBMITTED TO PUBLIC UTILITIES FOR REVIEW AND APPROVAL. ADDITIONAL WATER QUALITY AND EROSION CONTROL MEASURES MAY BE REQUIRED. THE CONTRACTOR MUST ALSO COMPLY WITH THE CITY'S CLEAN WHEEL ORDINANCE.

THE CONTRACTOR IS TO PROVIDE MARSHALL AND PROCTOR TEST DATA 24-HOURS PRIOR TO USE. CONTRACTOR IS TO PROVIDE COMPACTION AND DENSITY TESTING AS REQUIRED BY THE OWNER, UDOT, SALT LAKE COUNTY OR OTHER APPLICABLE GOVERNMENT ENTITY. TRENCH BACKFILL MATERIAL AND COMPACTION TESTS ARE TO BE TAKEN PER APWA STANDARD SPECIFICATIONS, SECTION 02320 - BACKFILLING TRENCHES, OR AS REQUIRED BY THE SLC PROJECT ENGINEER IF NATIVE MATERIALS ARE USED. NO NATIVE MATERIALS ARE ALLOWED WITHIN THE PIPE ZONE. THE MAXIMUM LIFTS FOR BACKFILLING EXCAVATIONS IS 8-INCHES. ALL MATERIALS AND COMPACTION TESTING IS TO BE PERFORMED BY A LAB RECOGNIZED AND ACCEPTED BY SPANISH FORK CITY PUBLIC WORKS AND THE OWNER'S REPRESENTATIVE.

#### 6. TRAFFIC CONTROL AND HAUL ROUTES

TRAFFIC CONTROL MUST CONFORM TO THE MOST CURRENT EDITION OF SALT LAKE CITY TRAFFIC BARRICADE MANUAL - PART 6 OF "MANUAL ON UNIFORM TRAFFIC CONTROL DEVICES" FOR SALT LAKE COUNTY AND STATE ROADS. THE CONTRACTOR MUST ALSO CONFORM TO UDOT, COUNTY OR OTHER APPLICABLE GOVERNMENT ENTITIES REQUIREMENTS FOR TRAFFIC CONTROL.

CONTRACTOR MUST PROVIDE A REGISTERED LAND SURVEYOR OR PERSONS UNDER SUPERVISION OF A REGISTERED LAND SURVEYOR TO SET STAKES FOR ALIGNMENT AND GRADE OF EACH MAIN AND/OR FACILITY AS SHOWN ON THE PLANS. THE STAKES SHALL BE MARKED WITH THE HORIZONTAL LOCATION (STATION) AND VERTICAL LOCATION (GRADE) WITH CUTS AND/OR FILLS TO THE APPROVED GRADE OF THE MAIN AND OR FACILITY AS SHOWN ON THE PLANS. CONTRACTOR WILL BE RESPONSIBLE FOR FURNISHING, MAINTAINING, OR RESTORING ALL MONUMENTS AND REFERENCE MARKS WITHIN THE PROJECT SITE.

THE CONTRACTOR SHALL FURNISH AND PLACE PERMANENT ASPHALT PER APWA STANDARD PLAN 255 OR UDOT, COUNTY, OR OTHER GOVERNMENT STANDARDS AS APPLICABLE TO THE PROJECT. THE CONTRACTOR SHALL GUARANTEE THE ASPHALT RESTORATION FOR A PERIOD OF TWO YEARS. ALL SAW CUTS MUST MEET CITY ENGINEERING, UDOT, SALT LAKE COUNTY OR OTHER STANDARDS AS APPLICABLE TO THE PROJECT

IF THE CONTRACTOR CHOOSES TO WORK ON A PUBLIC WORKS PROJECT OR WITHIN THE PUBLIC WAY WHEN HOT MIX ASPHALT IS NOT AVAILABLE, THE CONTRACTOR MUST OBTAIN APPROVAL FROM THE APPROPRIATE GOVERNMENT AGENCY PRIOR TO INSTALLING TEMPORARY ASPHALT SURFACING MATERIAL. WHEN PERMANENT ASPHALT BECOMES AVAILABLE, THE CONTRACTOR SHALL REMOVE THE TEMPORARY ASPHALT, FURNISH AND INSTALL THE PERMANENT ASPHALT. THE CONTRACTOR SHALL GUARANTEE THE ASPHALT RESTORATION FOR A PERIOD OF TWO YEARS FROM THE DATE OF COMPLETION.

#### THE CONTRACTOR IS RESPONSIBLE FOR THE SAFETY OF THE PROJECT AND SHALL MEET ALL OSHA REQUIREMENTS.

THE CONTRACTOR IS SOLELY RESPONSIBLE FOR CONFORMING TO LOCAL AND FEDERAL CODES GOVERNING SHORING AND BRACING OF EXCAVATIONS AND TRENCHES, AND FOR THE PROTECTION OF WORKERS.

THE CONTRACTOR IS RESPONSIBLE FOR DUST CONTROL ACCORDING TO GOVERNING AGENCY STANDARDS. USE OF HYDRANT WATER OR PUMPING FROM CITY OWNED CANALS OR STORM DRAINAGE FACILITIES IS NOT ALLOWED FOR DUST CONTROL ACTIVITIES.

ALL ON-SITE DEWATERING ACTIVITIES MUST BE APPROVED IN WRITING BY PUBLIC UTILITIES. PROPOSED OUTFALL LOCATIONS SHOWN ON THE PLANS AND ESTIMATED FLOW VOLUME CALCULATIONS MUST BE SUBMITTED TO PUBLIC UTILITIES FOR REVIEW AND APPROVAL. ADEQUATE MEASURES MUST BE TAKEN TO REMOVE ALL SEDIMENT PRIOR TO DISCHARGE. PUBLIC UTILITIES MAY REQUIRE ADDITIONAL MEASURES FOR SEDIMENT CONTROL AND

#### 13. RESPONSIBILITY / PROJECT LIMITS

THE CONTRACTOR SHALL TAKE ALL MEASURES NECESSARY TO PROTECT ALL EXISTING PUBLIC AND PRIVATE, ROADWAY AND UTILITY IMPROVEMENTS. DAMAGE TO EXISTING IMPROVEMENTS CAUSED BY THE CONTRACTOR, MUST BE REPAIRED BY THE CONTRACTOR AT HIS/HER EXPENSE, TO THE SATISFACTION OF THE OWNER OF SAID IMPROVEMENTS. THE CONTRACTOR IS REQUIRED TO KEEP ALL CONSTRUCTION ACTIVITIES WITH THE APPROVED PROJECT LIMITS. THIS INCLUDES, BUT IS NOT LIMITED TO, VEHICLE AND EQUIPMENT STAGING, MATERIAL STORAGE AND LIMITS OF TRENCH EXCAVATION. IT IS THE CONTRACTORS RESPONSIBILITY TO OBTAIN PERMISSION AND/OR EASEMENTS FROM THE APPROPRIATE GOVERNMENT AGENCY AND/OR INDIVIDUAL PROPERTY OWNER(S) FOR WORK OR STAGING OUTSIDE OF THE PROJECT LIMITS.

#### 14. UTILITIES

A. INSPECTIONS — IT IS THE CONTRACTOR'S RESPONSIBILITY TO SCHEDULE INSPECTIONS AS APPLICABLE TO THE PROJECT 48-HOURS PRIOR TO WHEN NEEDED.

B. DAMAGE TO EXISTING UTILITIES - THE CONTRACTOR IS RESPONSIBLE FOR REPAIRING ANY DAMAGE, CAUSED BY ANY CONDITION INCLUDING SETTLEMENT, TO EXISTING UTILITIES FROM WORK PERFORMED AT OR NEAR EXISTING UTILITIES.

C. UTILITY LOCATIONS — CONTRACTOR WILL BE RESPONSIBLE FOR LOCATING AND AVOIDING ALL UTILITIES AND SERVICE LATERALS, AND FOR REPAIRING ALL DAMAGE THAT OCCURS TO THE UTILITIES DUE TO THE CONTRACTOR'S ACTIVITIES.

D. POTHOLING —CONTRACTOR IS TO VERIFY LOCATION, DEPTH, SIZE, TYPE AND OUTSIDE DIAMETERS OF UTILITIES IN THE FIELD BY POTHOLING A MINIMUM OF 300 FEET AHEAD OF PIPELINE CONSTRUCTION TO AVOID CONFLICTS WITH DESIGNED PIPELINE GRADE AND ALIGNMENT.

E. UTILITY RELOCATIONS - FOR UTILITY CONFLICTS REQUIRING MAINLINE RELOCATIONS, THE CONTRACTOR MUST NOTIFY THE APPLICABLE UTILITY COMPANY OR USER A MINIMUM OF 2-WEEKS IN ADVANCE. ONE WEEK NOTIFICATION IS REQUIRED FOR CONFLICTS REQUIRING THE RELOCATION OF SERVICE LATERALS. ALL RELOCATIONS ARE SUBJECT TO APPROVAL FROM THE APPLICABLE UTILITY COMPANY OR USER.

DISTRIBUTE WRITTEN NOTICE TO ALL POTENTIALLY AFFECTED PROPERTY OWNERS LOCATED WITHIN THE PROJECT AREA AT LEAST 72-HOURS PRIOR

F. FIELD CHANGES —NO ROADWAY OR UTILITY ALIGNMENT OR GRADE CHANGES ARE ALLOWED FROM THE APPROVED CONSTRUCTION PLANS/DOCUMENTS WITHOUT APPROVAL FROM THE OWNERS REPRESENTATIVE. G. PUBLIC NOTICE TO PROJECTS IN THE PUBLIC WAY- FOR WORK IN THE PUBLIC WAY, THE CONTRACTOR IS RESPONSIBLE TO PROVIDE AND

INDEX OF DRAWINGS

COVER SHEET C-1

TO CONSTRUCTION.

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PARKING GRADING AND DRAINAGE PLAN

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BUILDING SITE PLAN 0 - 4

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0 - 6

FLOOR PLAN, ROOF PLAN & DETAILS

INDER OF ELECTRICAL DRAWINGS

SYMBOLS, SCHEDULES NOTE, & FLOOR PLANS


ELECRICAL SITE PLAN

ONE LINE DIAGRAM & PANELBOARD SCHEDULE



ENGINEER: GREG M. PUTNAM

DATE:

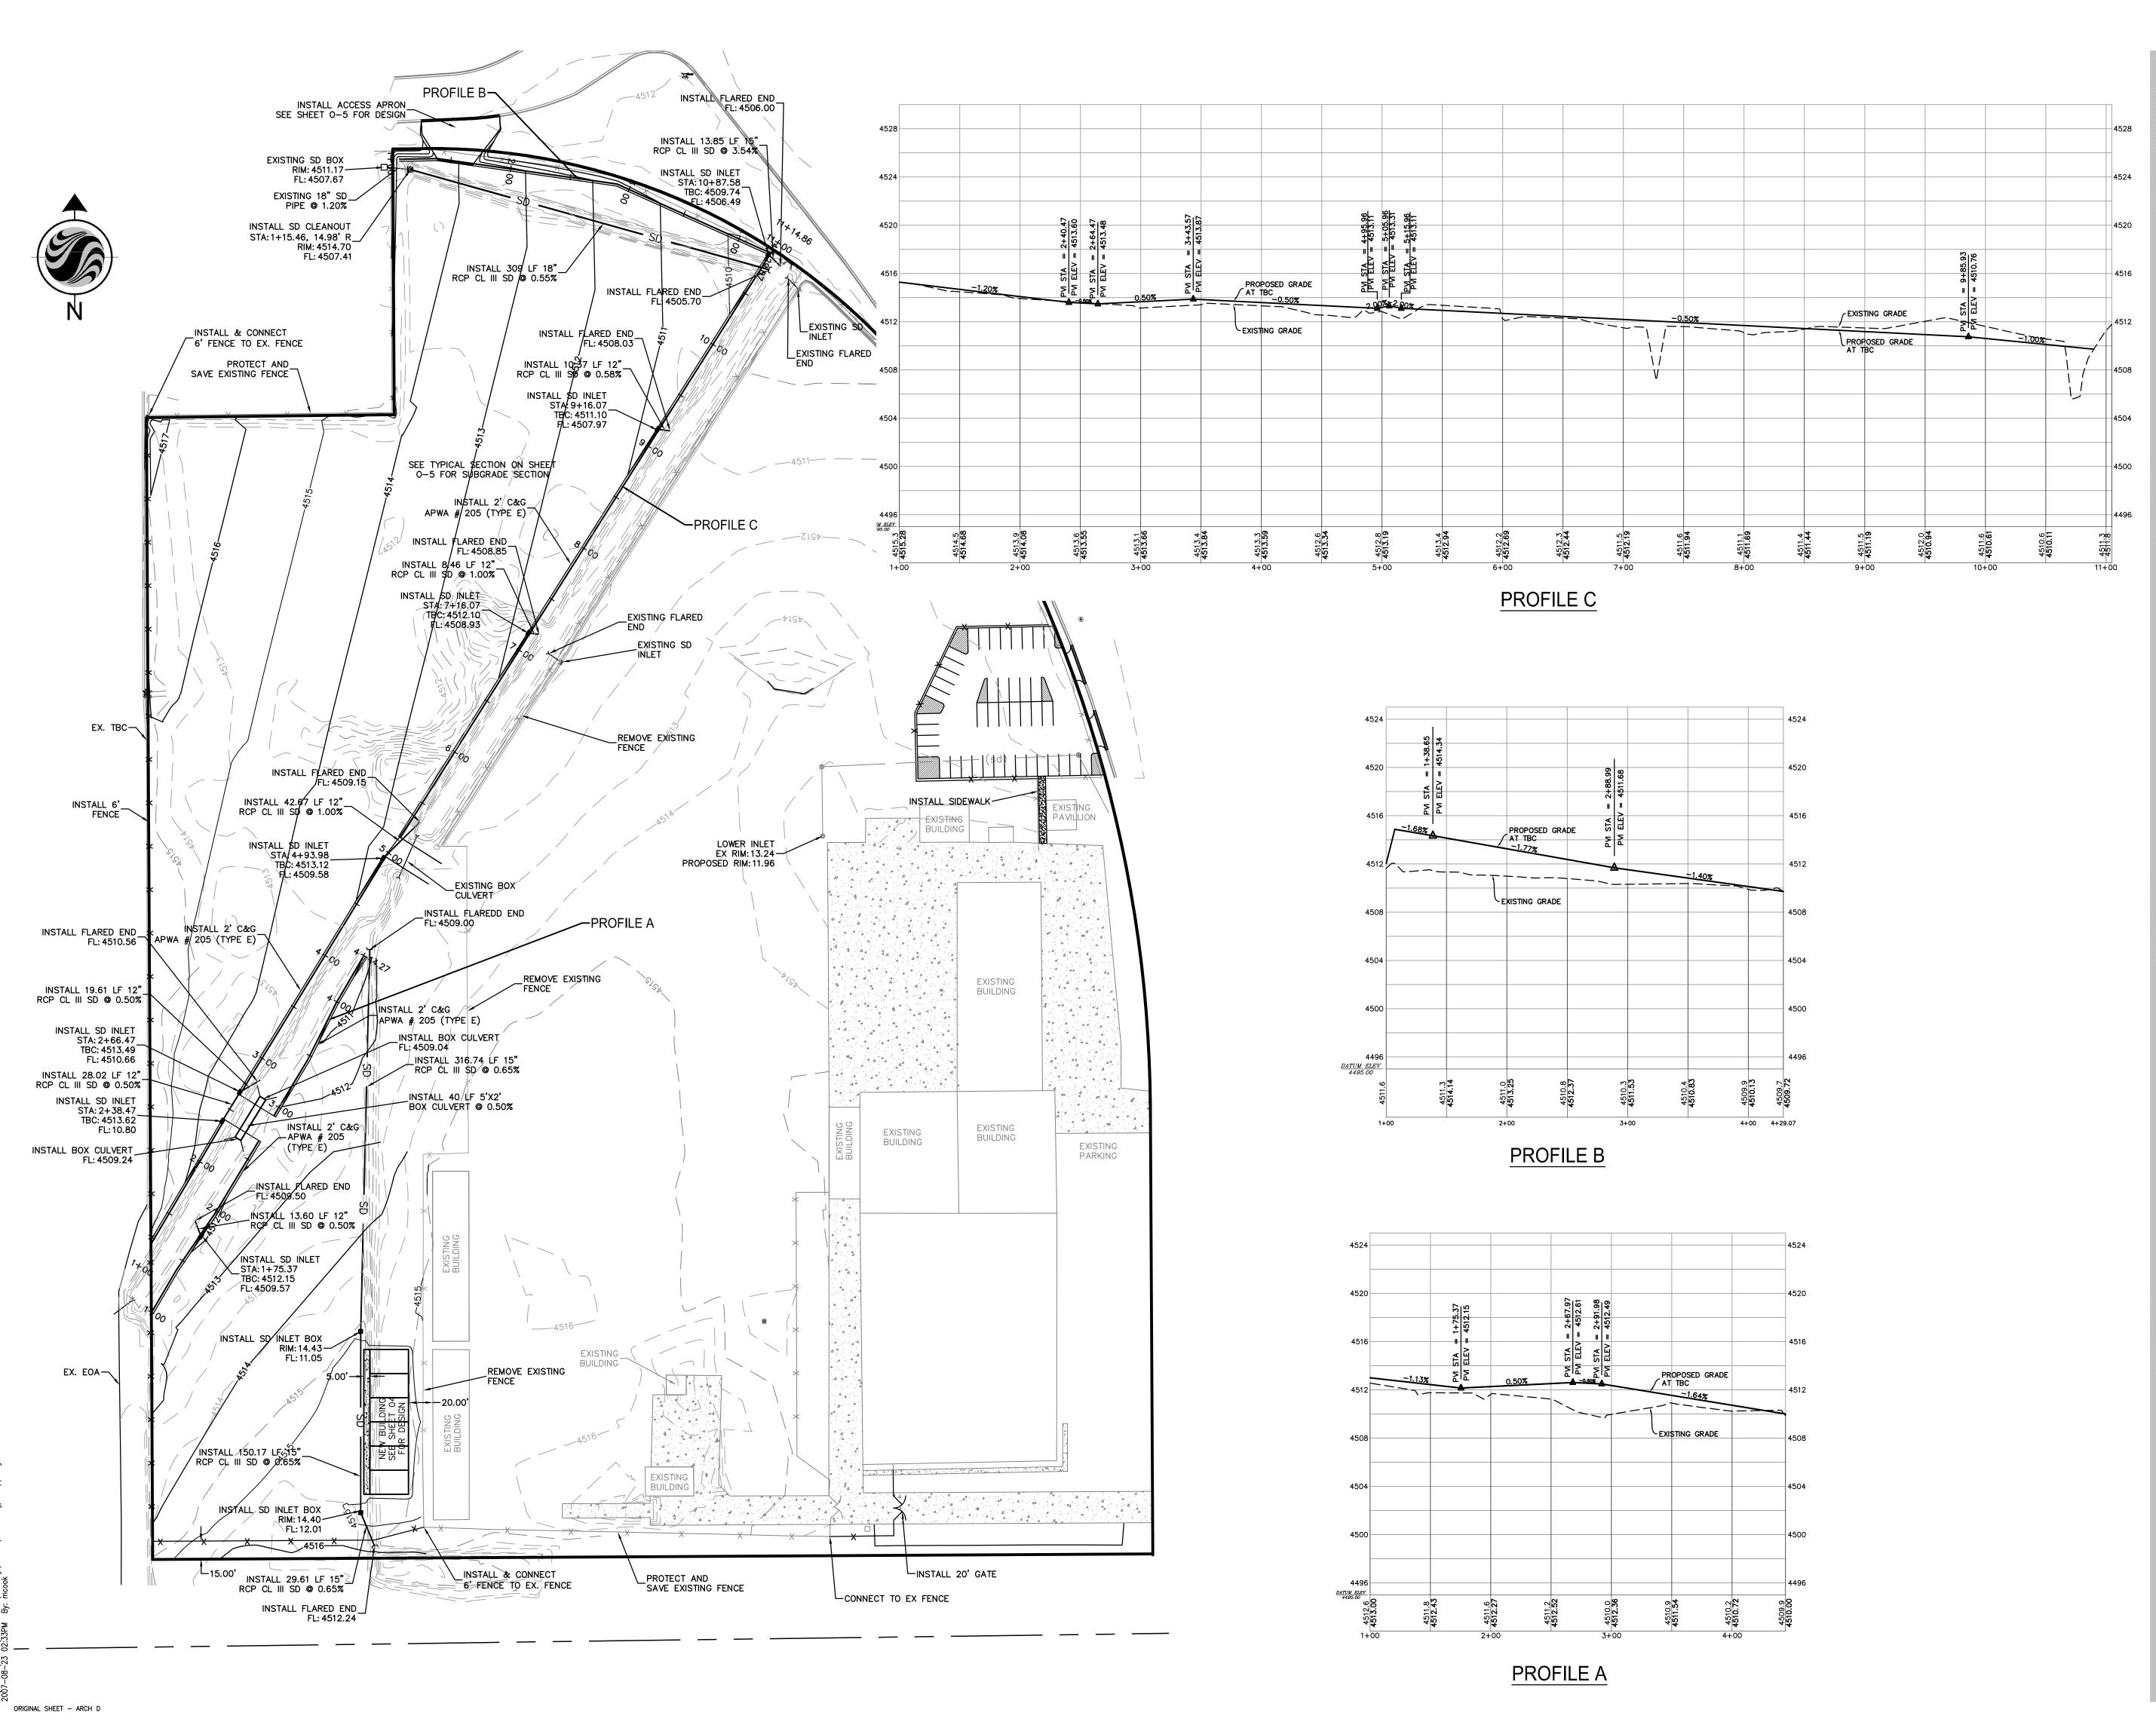



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Legend

#### LEGEND

SD	RCP CL III STORM DRAIN
——————————————————————————————————————	EXISTING STORM DRAIN
	SD COMBOBOX, CB & CO
	EXISTING GRADE CONTOUR
4500	FINISH GRADE CONTOURS
-X X X	EXISTING FENCE

Note



Revision		Ву	Appd.	YY.MM.DD
1 PRELIMINARY SUBMITTAL  Issued		AEA By	GP Appd.	07/10/07 YY.MM.DD
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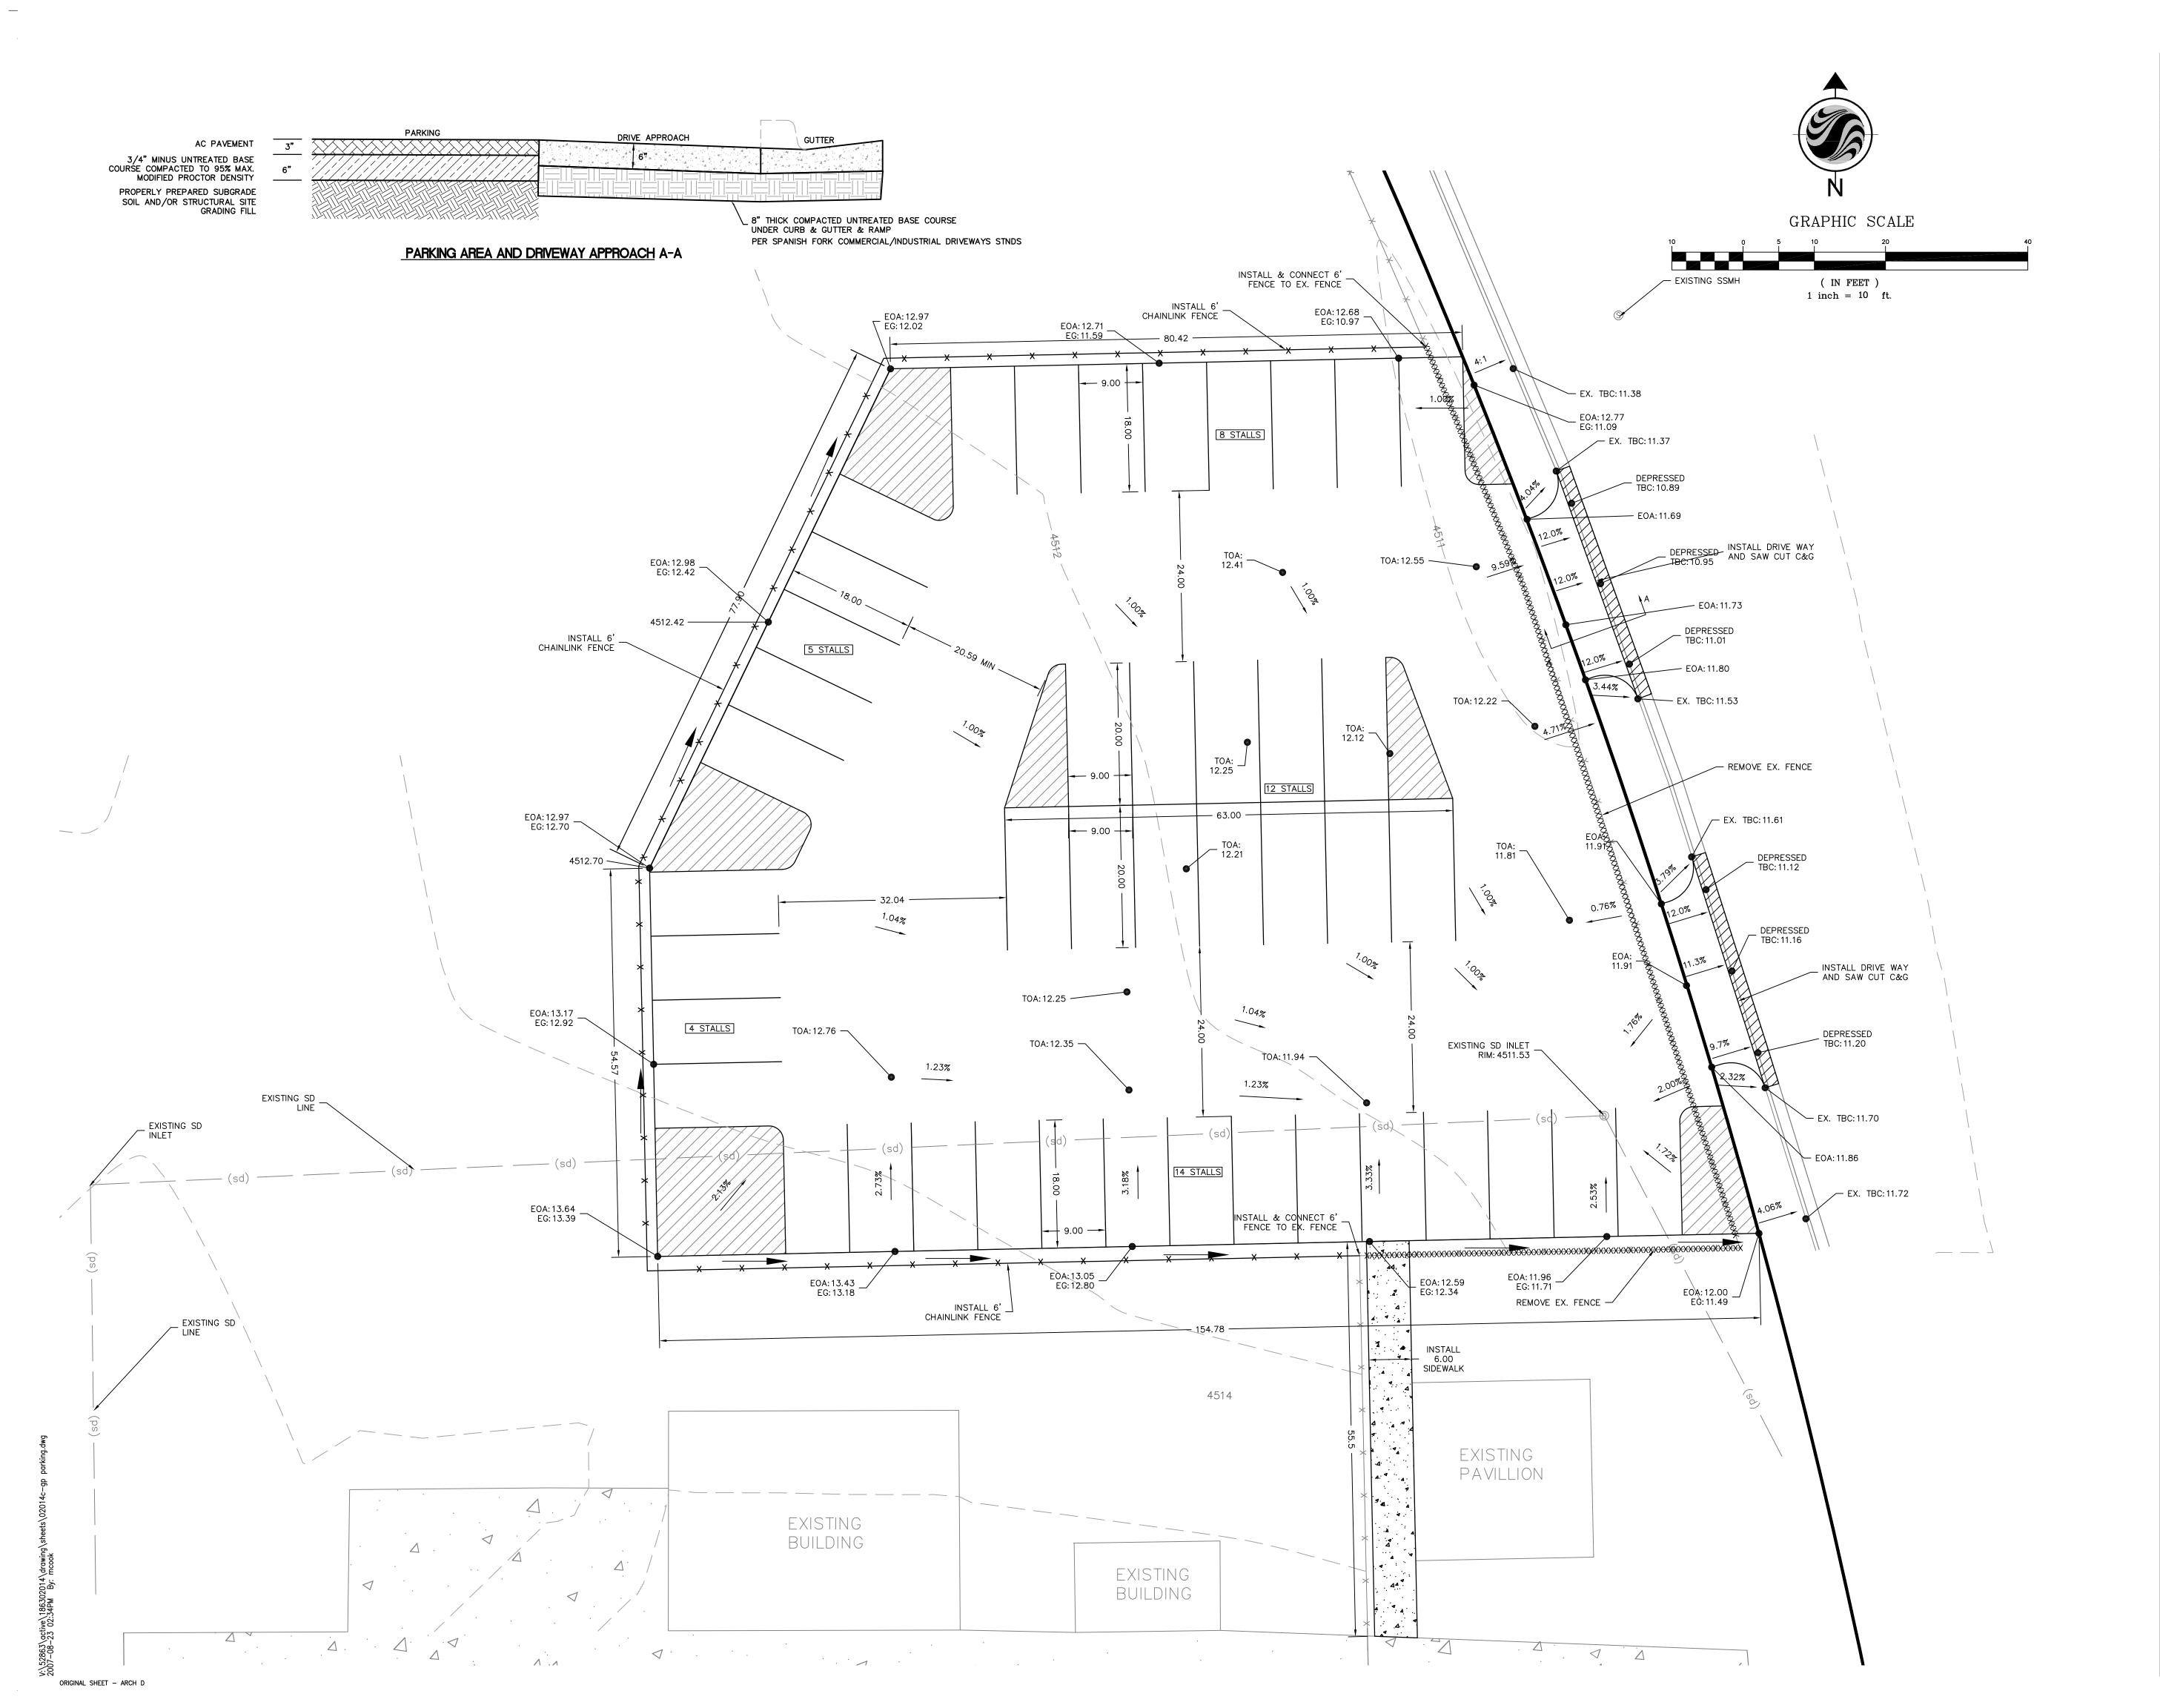
UTAH NATIONAL GUARD

SPANISH FORK ARMORY PARKING IMPROVEMENTS
Spanish Fork UT U.S.A.

Title

OVERALL GRADING PLAN

Project No. 186302014	Scale 1" = 60'	
Drawing No.	Sheet	Revision
0-1	of	0





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LEGEND

LEGEND

RCP CL III STORM DRAIN

4500——— FINISH GRADE CONTOURS

Notes



Revision		By	Appd.	YY.MM.DE
1 PRELIMINARY SUBMITTAL			 	07/10/0
Issued		Ву	Appd.	YY.MM.DD
File Name: 02014c-gp parking.dwg	AEA	GP	AEA	07/05/0

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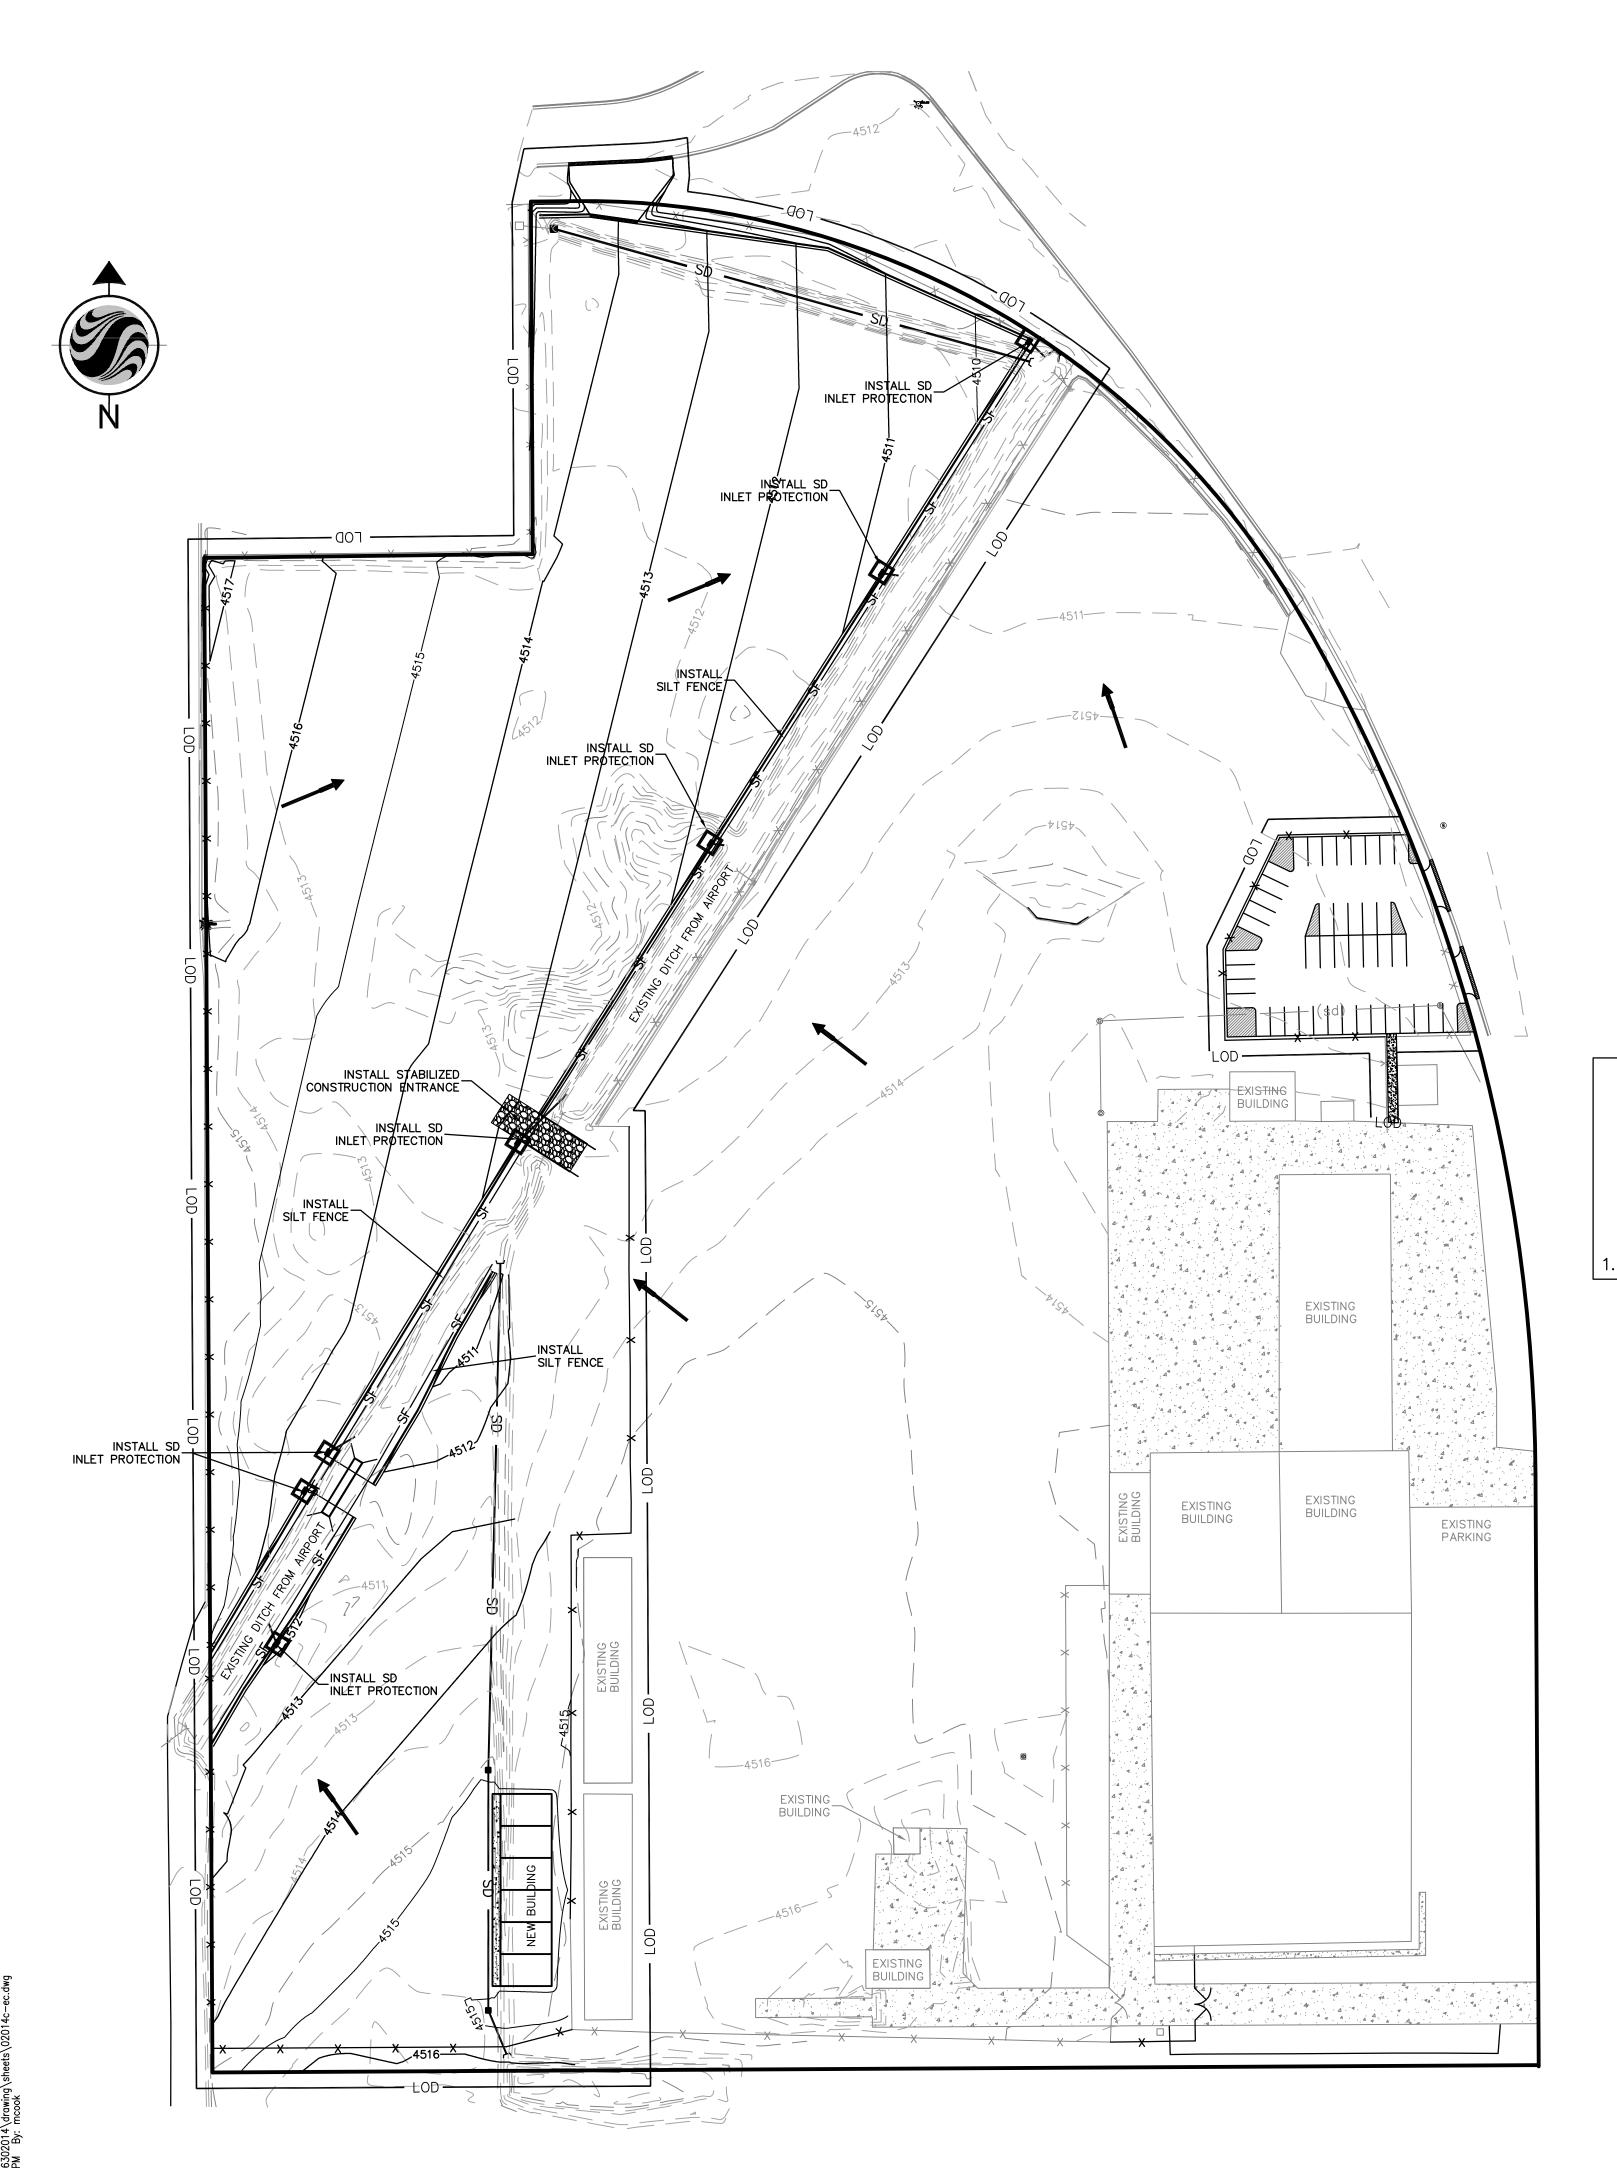
SPANISH FORK ARMORY PARKING IMPROVEMENTS
Spanish Fork UT U.S.A.


Title

PARKING GRADING AND DRAINAGE PLAN

Project No. Scale
186302014 1" = 10'


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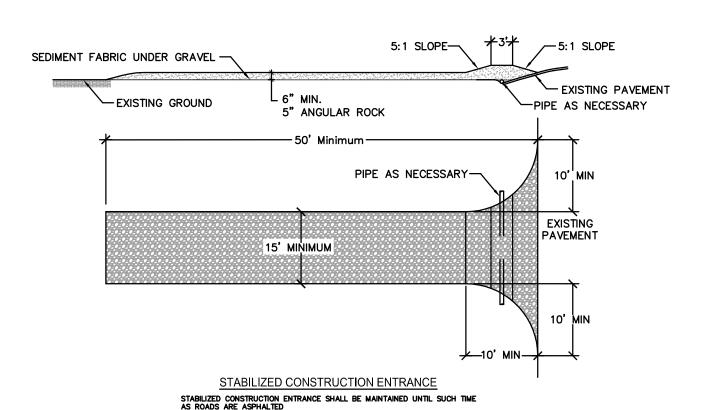


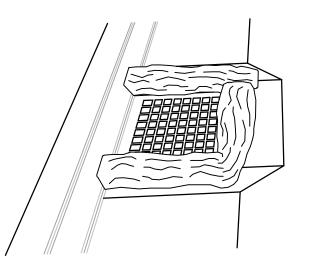


INLET PROTECTION - WATTLE

WATTLE MAY BE GRAVEL FILLED OR STRAW FILLED. INSTALL WHEN CONSTRUCTION OF CURB AND GUTTER AND ROADWAYS IS COMPLETE.



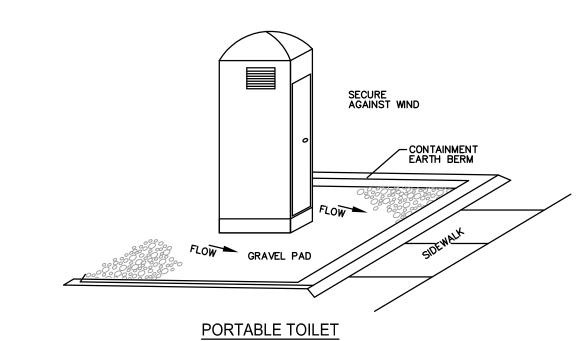

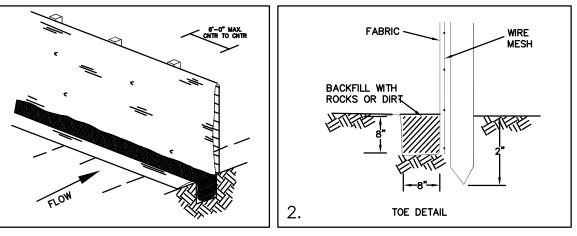

SILT FENCE

SILT FENCE MAY BE INSTALLED FOR PERIMETER CONTROL.

A MINIMUM 20-FOOT VEGETATED BUFFER MAY ALSO BE SUBSTITUTED FOR PERIMETER CONTROL

(PRESERVATION OF EXISTING VEGETATION).

#### EROSION CONTROL NOTES:

- 1. CONTROLLING SEDIMENT TRANSPORT AND PREVENTING AND/OR CORRECTING PROBLEMS
  ASSOCIATED WITH EROSION AND RUNOFF PROCESSES THAT COULD OCCUR BOTH DURING AND AFTER
  PROJECT CONSTRCUTION WILL BE CLOSELY MONITORED. PERIODIC MAINTENANCE AND INSPECTION
  OF SEDIMENT CONTROL DEVICES WILL BE SCHEDULED. PARTICULAR ATTENTION SHALL BE GIVEN TO
  EXISTING DRAINAGE PATTERNS THAT RUN THROUGH DISTURBED AREAS AND OVER EXTREME SLOPES.
  THESE PATTERNS WILL BE IDENTIFIED TO ISOLATE PROBLEM AREAS WHERE WATER WILL
  CONCENTRATE. PROVISIONS SHALL BE MADE TO CHANNEL RUNOFF AWAY FROM NEW OR EXISTING
  IMPROVEMENTS TO PREVENT UNDERMINING AND GENERAL SITE EROSION. THESE PROVISIONS SHALL
  BE STABILIZED AND SHALL REMAIN IN PLACE UNTIL THE PERMANENT STORM DRAINAGE FACILITIES ARE
  INSTALLED AND FUNCTIONAL.
- 2. EROSION CONTROL A STORMWATER POLLUTION PRVENTION PLAN (SWPPP) HAS BEEN PREPARED IN ACCORDANCE WITH THE UTAH POLLUTANT DISCHARGE ELIMINATION SYSTEM (UPDES) PERMIT FOR CONSTRUCTION, OUTLINING HOW EROSION AND SILTATION WILL BE CONTROLLED. A NOTICE OF INTENT (NOI) HAS BEEN SUBMITTED TO OBTAIN THE UPDES CONSTRUCTION PERMIT. A COPY OF THE PLAN MUST BE ON SITE AT ALL TIMES. THE CONTRACTOR SHALL BE RESPONSIBLE FOR IMPLEMENTING THE PLAN AND INSTALLING AND MAINTAINING THE EROSION CONTROL FACILITIES WITH EACH PHASE OF WORK. SHOULD SILT LEAVE THE SITE OR EROSION OCCURS, IT WILL BE THE CONTRACTOR'S RESPONSIBILITY TO TAKE CORRECTIVE ACTION AND REPAIR ANY DAMAGE CAUSED BY THE SILT OR EROSION IMMEDIATELY. ALL COSTS ASSOCIATED WITH THE MODIFICATION AND APPROVAL OF THE PLAN WILL BE THE RESPONSIBILITY OF THE CONTRACTOR.
- 3. BEFORE CONSTRUCTION BEGINS, THE LIMITS OF DISTURBANCE (LOD) BOUNDARY SHALL BE FLAGGED ON SITE AND APPROVED BY THE ENGINEER. UNDER NO CIRCUMSTANCES SHALL SITE DISTURBANCE OCCUR OUTSIDE THE DESIGNATED AREAS AT ANY TIME DURING CONSTRUCTION.
- 4. EXCAVATION AND EMBANKMENT OPERATIONS SHALL PROCEED IN SUCH A MANNER SO THAT FINISHING OF SLOPES, INCLUDING REVEGETATION SHALL BE ACCOMPLISHED AS SOON AS POSSIBLE AFTER ROUGH GRADING. ALL SLOPES 2:1 OR FLATTER SHALL BE SCARIFIED WITH HEAVY EQUIPMENT, LEAVING TRACKS PERPENDICULAR TO THE SLOPE.
- 5. CUT SLOPES SHALL BE 1:1 MAXIMUM AND FILL SLOPES 2:1 MAXIMUM UNLESS ROCK IS ENCOUNTERED. CUT SLOPES IN ROCK MAY BE STEEPENED, DEPENDING UPON GEOTECHNICAL CONSIDERATIONS. THE TOPS OF ALL CUT SLOPES IN SOIL SHALL BE ROUNDED FOR A HORIZONTAL DISTANCE OF THREE (3) FEET BEYOND THE CATCH POINT. SLOPE ROUNDING SHALL OCCUR AS THE SLOPE IS BEING BROUGHT DOWN. THE OVERALL SHAPE, HEIGHT AND GRADE OF ANY CUT AND/OR FILL SLOPE SHALL BE DEVELOPED IN CONCERT WITH THE EXISTING NATURAL CONTOURS, SCALE AND VEGETATION OF NATURAL TERRAIN.
- 6. STABILIZATION PRACTICES MAY INCLUDE, BUT NOT BE LIMITED TO, TEMPORARY SEEDING, PERMANENT SEEDING, MULCHING, GEOTEXTILES, SOD STABILIZATION, VEGETATIVE BUFFER STRIPS, PROTECTION OF TREES, PRESERVATION OF NATURAL VEGETATION AND OTHER APPROPRIATE MEASURES. USE OF IMPERVIOUS SURFACES FOR STABILIZATION SHALL BE AVOIDED. EXCEPT AS PROVIDED BELOW, STABILIZATION MEASURES SHALL BE INITIATED AS SOON AS POSSIBLE IN DISTURBED PORTIONS OF THE SITE WHERE CONSTRUCTION ACTIVITIES HAVE PERMANENTLY CEASED, BUT IN NO CASE MORE THAN 14 DAYS AFTER THE CONSTRUCTION ACTIVITY IN THAT PORTION OF THE SITE HAS TEMPORARILY OR PERMANENTLY CEASED.
- A. WHERE DEEP SNOW OR FROZEN GROUND CONDITIONS PRECLUDE THE INITIATION OF STABILIZATION MEASURES BY THE 14TH DAY AFTER CONSTRUCTION ACTIVITY PERMANENTLY CEASES, STABILIZATION MEASURES SHALL BE INITIATED AS SOON AS PRECTICABLE.
- B. WHERE CONSTRUCTION ACTIVITY ON A PORTION OF THE SITE IS TEMPORARILY CEASED, AND EARTH DISTURBING WILL RESUME WITHIN 21 WORKING DAYS, TEMPORARY STABILIZATION MEASURES NEED NOT BE INITIATED ON THAT PORTION OF THE SITE.

7. SPECIFICALLY OUTLINED DISTURBED AREAS, BOTH ON AND OFF-SITE SHALL BE REVEGETATED. THESE

- AREAS SHALL INCLUDE, BUT NOT BE LIMITED TO, ALL UNSURFACED AREAS WITHIN THE FLAGGED LOD, STAGING AND STORAGE AREAS, MATERIAL WASTE AREAS, UNDERGROUND UTILITY CONSTRUCTION AREAS, BENCHED AREAS, INCLUDE RETAINING WALL BENCHES, AND TEMPORARY OR EXISTING ACCESS ROADS USED FOR CONSTRUCTION ACTIVITIES. CUT AND FILL SLOPES OVER 3:1 REQUIRE THE PLACEMENT OF EROSION CONTROL/REVEGETATION MATTING. SLOPES LESS THAN 3:1 MAY BE SPRAYED WITH TACKIFIER. ROCK CUTS STEEPER THAN 1:1 WILL NOT BE REVEGETATED.
- 8. SEDIMENT TRAPS MUST OUTLET ONTO STABILIZED (PREFERABLY UNDISTURBED) GROUND OR LEFT TO PERCOLATE INTO THE GROUND.
- 9. CONTROLLED OUTLETS SHALL DIRECT COLLECTED RUNOFF THROUGH SILT FENCES OR STRAW BALES
- 10. TYPICAL FUGITIVE DUST SHALL BE CONTROLLED BY WATERING AND/OR CHEMICAL STABILIZATION, PROVIDING VEGETATIVE OR SYNTHETIC COVER AND WIND BREAKS ARE CONSISTENT WITH THE UTAH STATE DIVISION OF AIR QUALITY STANDARDS.
- 11. ANY SEDIMENT TRACKED OFF-SITE SHALL BE REMOVED PRIOR TO THE END OF THE WORK SHIFT OR PRIOR TO SUNSET, WHICHEVER COMES FIRST.
- 12. CONTRACTOR MAY ADJUST THE LOCATIONS OF THE CONSTRUCTION FENCE, CONSTRUCTION TRAILERS, AND CONSTRUCTION MATERIALS RECEIVING ANS STORAGE AREAS, AS NEEDED TO ACCOMPLISH THE CONSTRUCTION. ALL CHANGES SHALL BE NOTATED ON THE EROSION CONTROL
- 13. CONTRACTOR SHALL CONDUCT PERIODIC INSPECTIONS OF THE EROSION CONTROL MEASURES, AS REQUIRED AND NOTATED IN THE SWPPP. THE CONTRACTOR WILL MAINTAIN A LOG ON-SITE OF ALL INSPECTIONS WITH THE SWPPP.



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Legend

LEGEN

EXISTING GROUND CONTOUR

FINISH GRADE CONTOUR

STORM DRAIN

DIRECTION OF FLOW

SF SILT FENCE

INLET PROTECTION

STABILIZED CONSTRUCTION

—— LOD —— LIMITS OF DISTURBANCE



Revision

By Appd. YY.MM.DD

1 PRELIMINARY SUBMITTAL
AEA GP 07/10/07
Issued

By Appd. YY.MM.DD

File Name: 02014c-gp.dwg
AEA GP AEA 07/05/07
Dwn. Chkd. Dsgn. YY.MM.DD

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SPANISH FORK ARMORY PARKING IMPROVEMENTS
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Title

EROSION CONTROL PLAN


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 Scale

 186302014
 1" = 60'

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ORIGINAL SHEET - ARCH D



SEC VIEW - 3 TIE BEAM

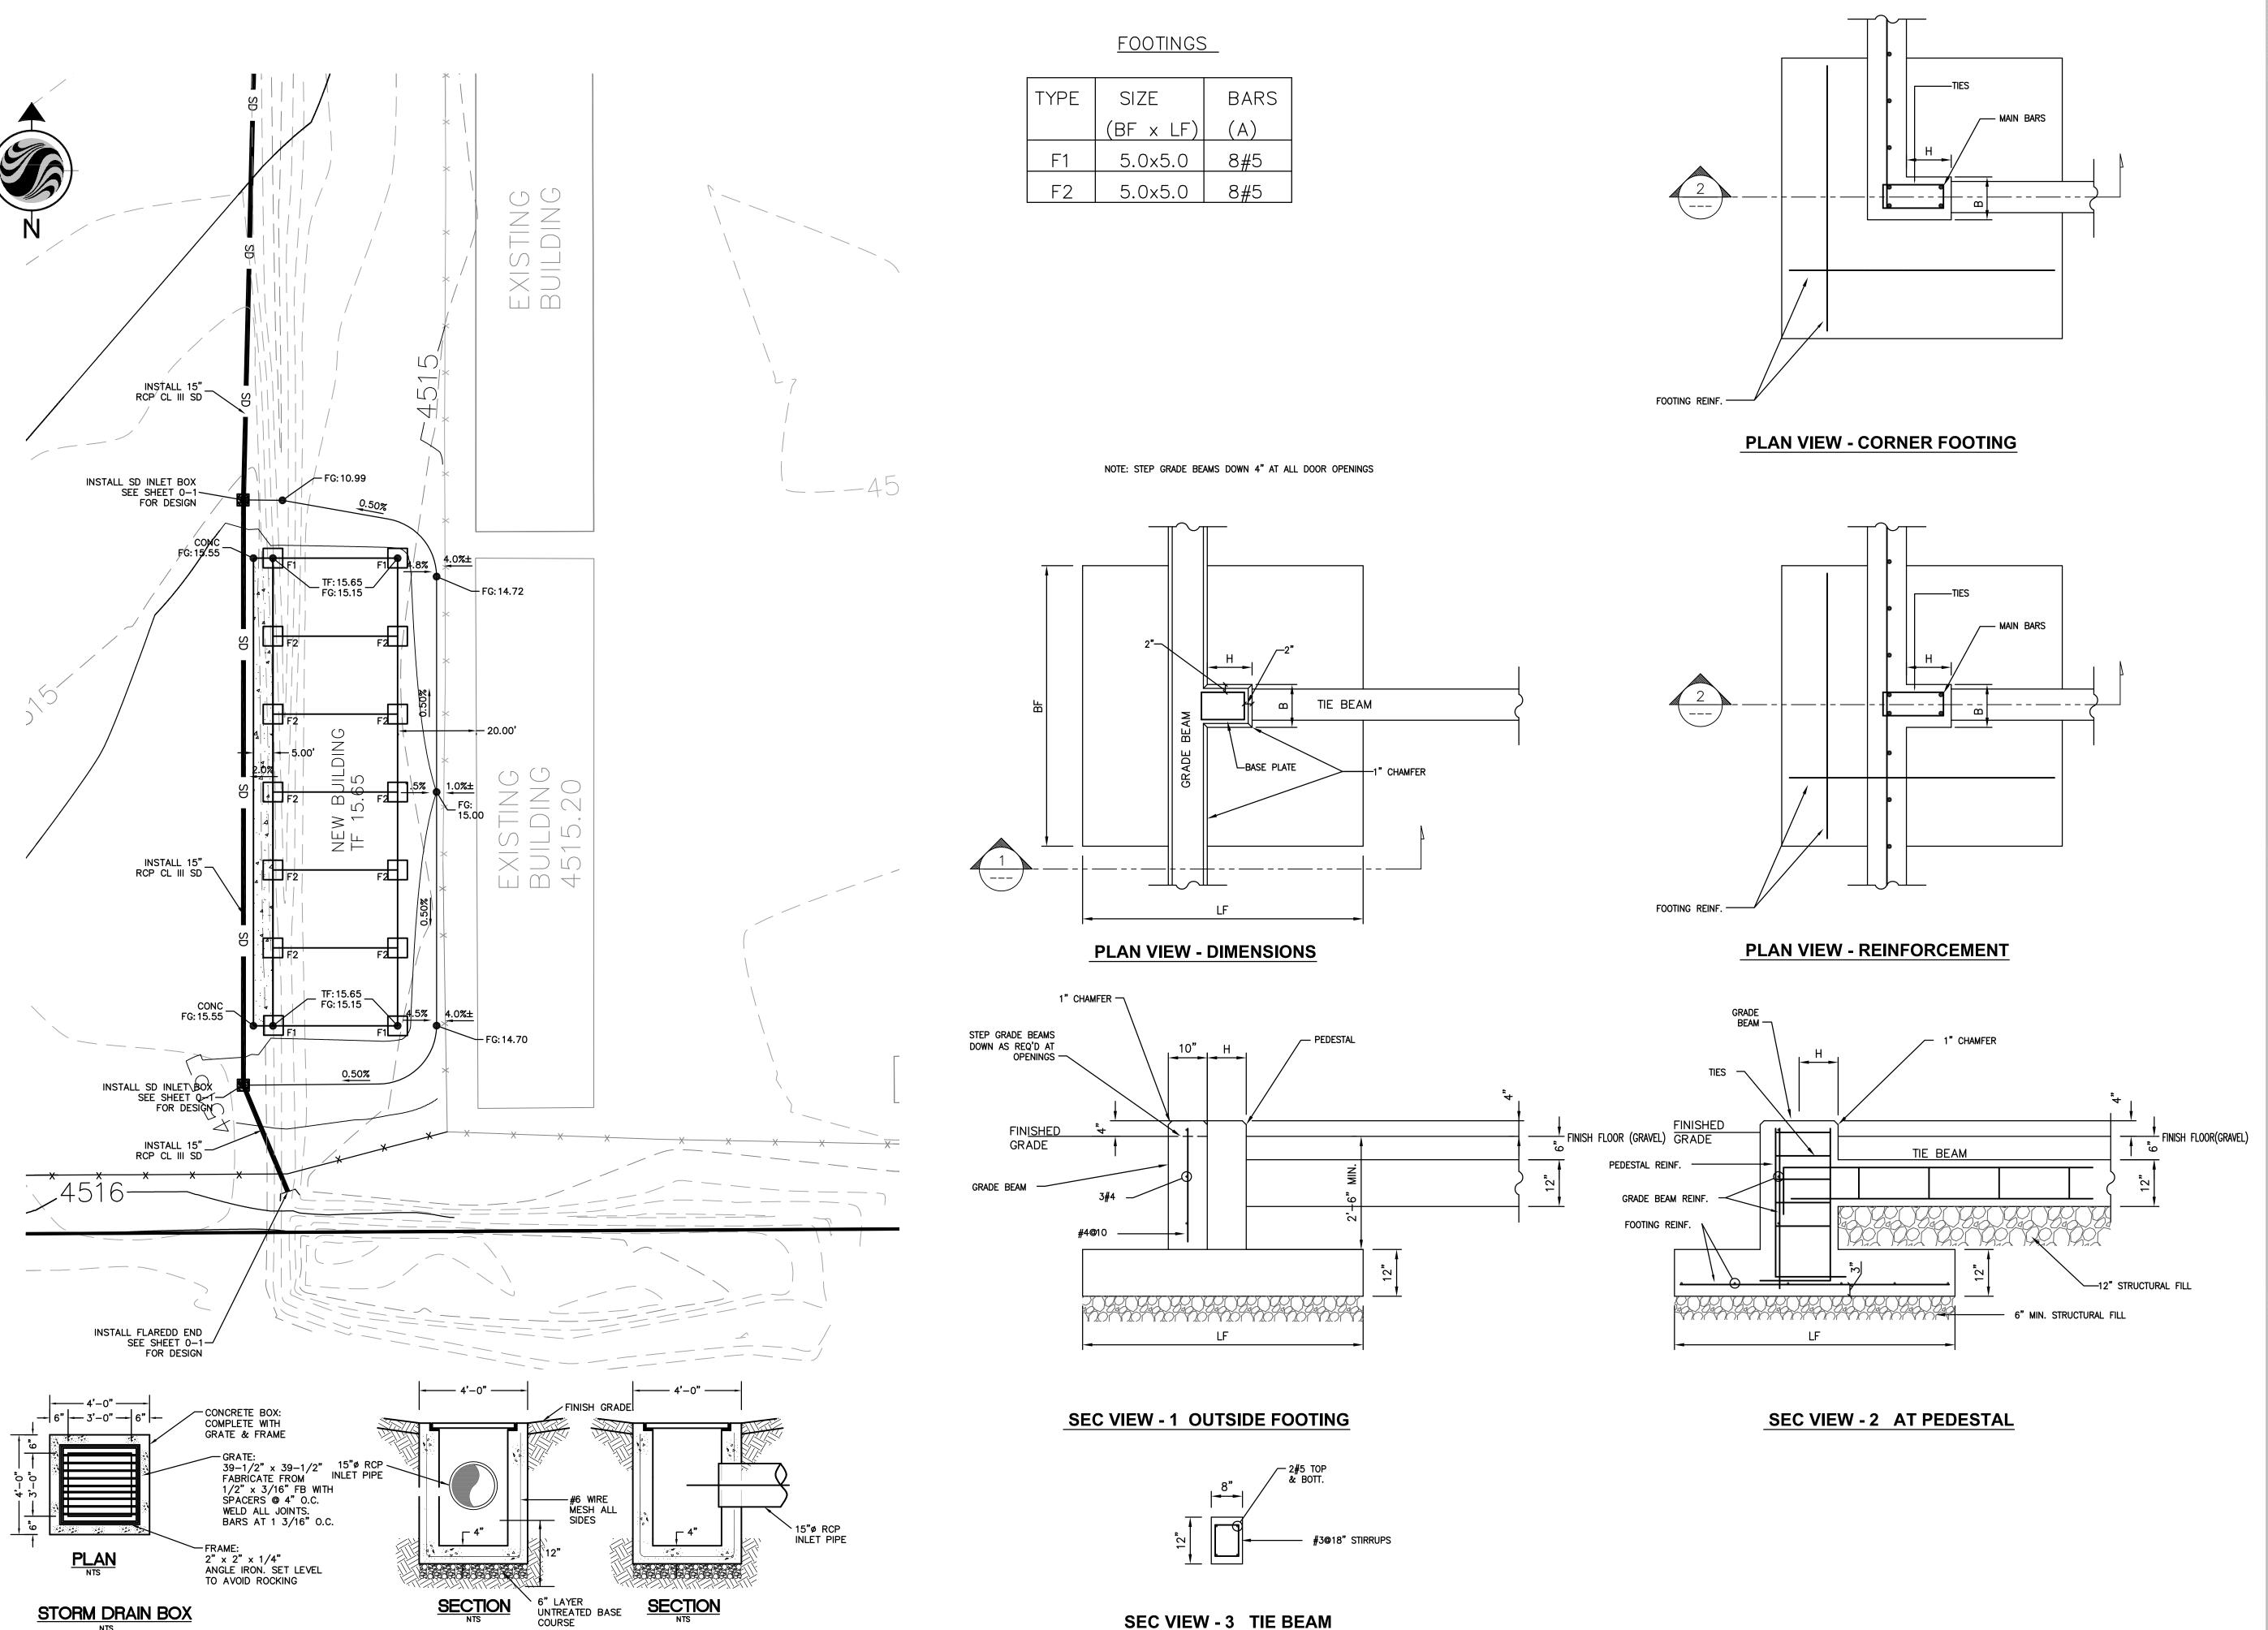ORIGINAL SHEET - ARCH D



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#### LEGEND

SD	RCP CL III STORM DRAIN
—— (bd) ——	EXISTING STORM DRAIN
	SD COMBOBOX, CB & CO
	EXISTING GRADE CONTOURS
4500	FINISH GRADE CONTOURS
-X X X	EXISTING FENCE



Revision	 Appd.	YY.MM.DD
1 PRELIMINARY SUBMITTAL	  	07/10/07
Issued	 Appd.	YY.MM.DD

File Name: 02014c-building site plan.dwg AEA GP AEA 07/05/07

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1- FOR BIDDING PURPOSES ONLY. NOT FOR CONSTRUCTION
2- FOUNDATION DIMENTIONS & REINFORCEMENT MIGHT CHANGE
PENDING GEOTECHNICAL INFORMATION & FOUNDATION REACTIONS
& OTHER BUILDING FACTORS

Client/Project

UTAH NATIONAL GUARD

SPANISH FORK ARMORY PARKING IMPROVEMENTS Spanish Fork UT U.S.A.


**BUILDING SITE PLAN** 

Project No. 186302014	Scale 1" = 20'	
Drawing No.	Sheet	Revision
0-4	of	0



PROPERLY PREPARED SUBGRADE SOIL STRUCTURAL SITE GRADING FILL

UNDISTURBED NATIVE SOIL

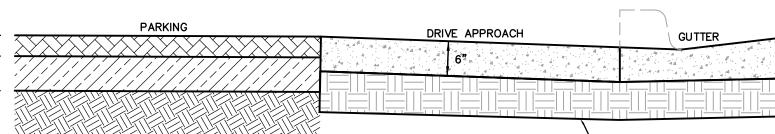

8" THICK COMPACTED UNTREATED BASE COURSE UNDER CURB & GUTTER & RAMP
PER SPANISH FORK COMMERCIAL/INDUSTRIAL DRIVEWAYS STNDS

PARKING AREA AND ACCESS APRON A-A

DEPRESS -EX. TBC:11.95 DEPRESS \_ EX. TBC:11.85 DEPRESS \_ EX. TBC: 11.76 CONC: 12.58 CONC: 13.64 -\ DEPRESSED TBC:13.84 DEPRESSED TBC:13.58 L DEPRESSED TBC: 13.31



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#### LEGEND

SD	RCP CL III STORM DRAIN
(sd)	EXISTING STORM DRAIN
	SD COMBOBOX, CB & CC
	EXISTING GRADE CONTOU
4500	FINISH GRADE CONTOURS
-X X X	EXISTING FENCE

Notes



Revision	By	Appd.	YY.MM.DE
1 PRELIMINARY SUBMITTAL		  GP	07/10/0
Issued	Ву	Appd.	YY.MM.DI

File Name: 02014c-building site plan.dwg AEA GP AEA 07/05/07

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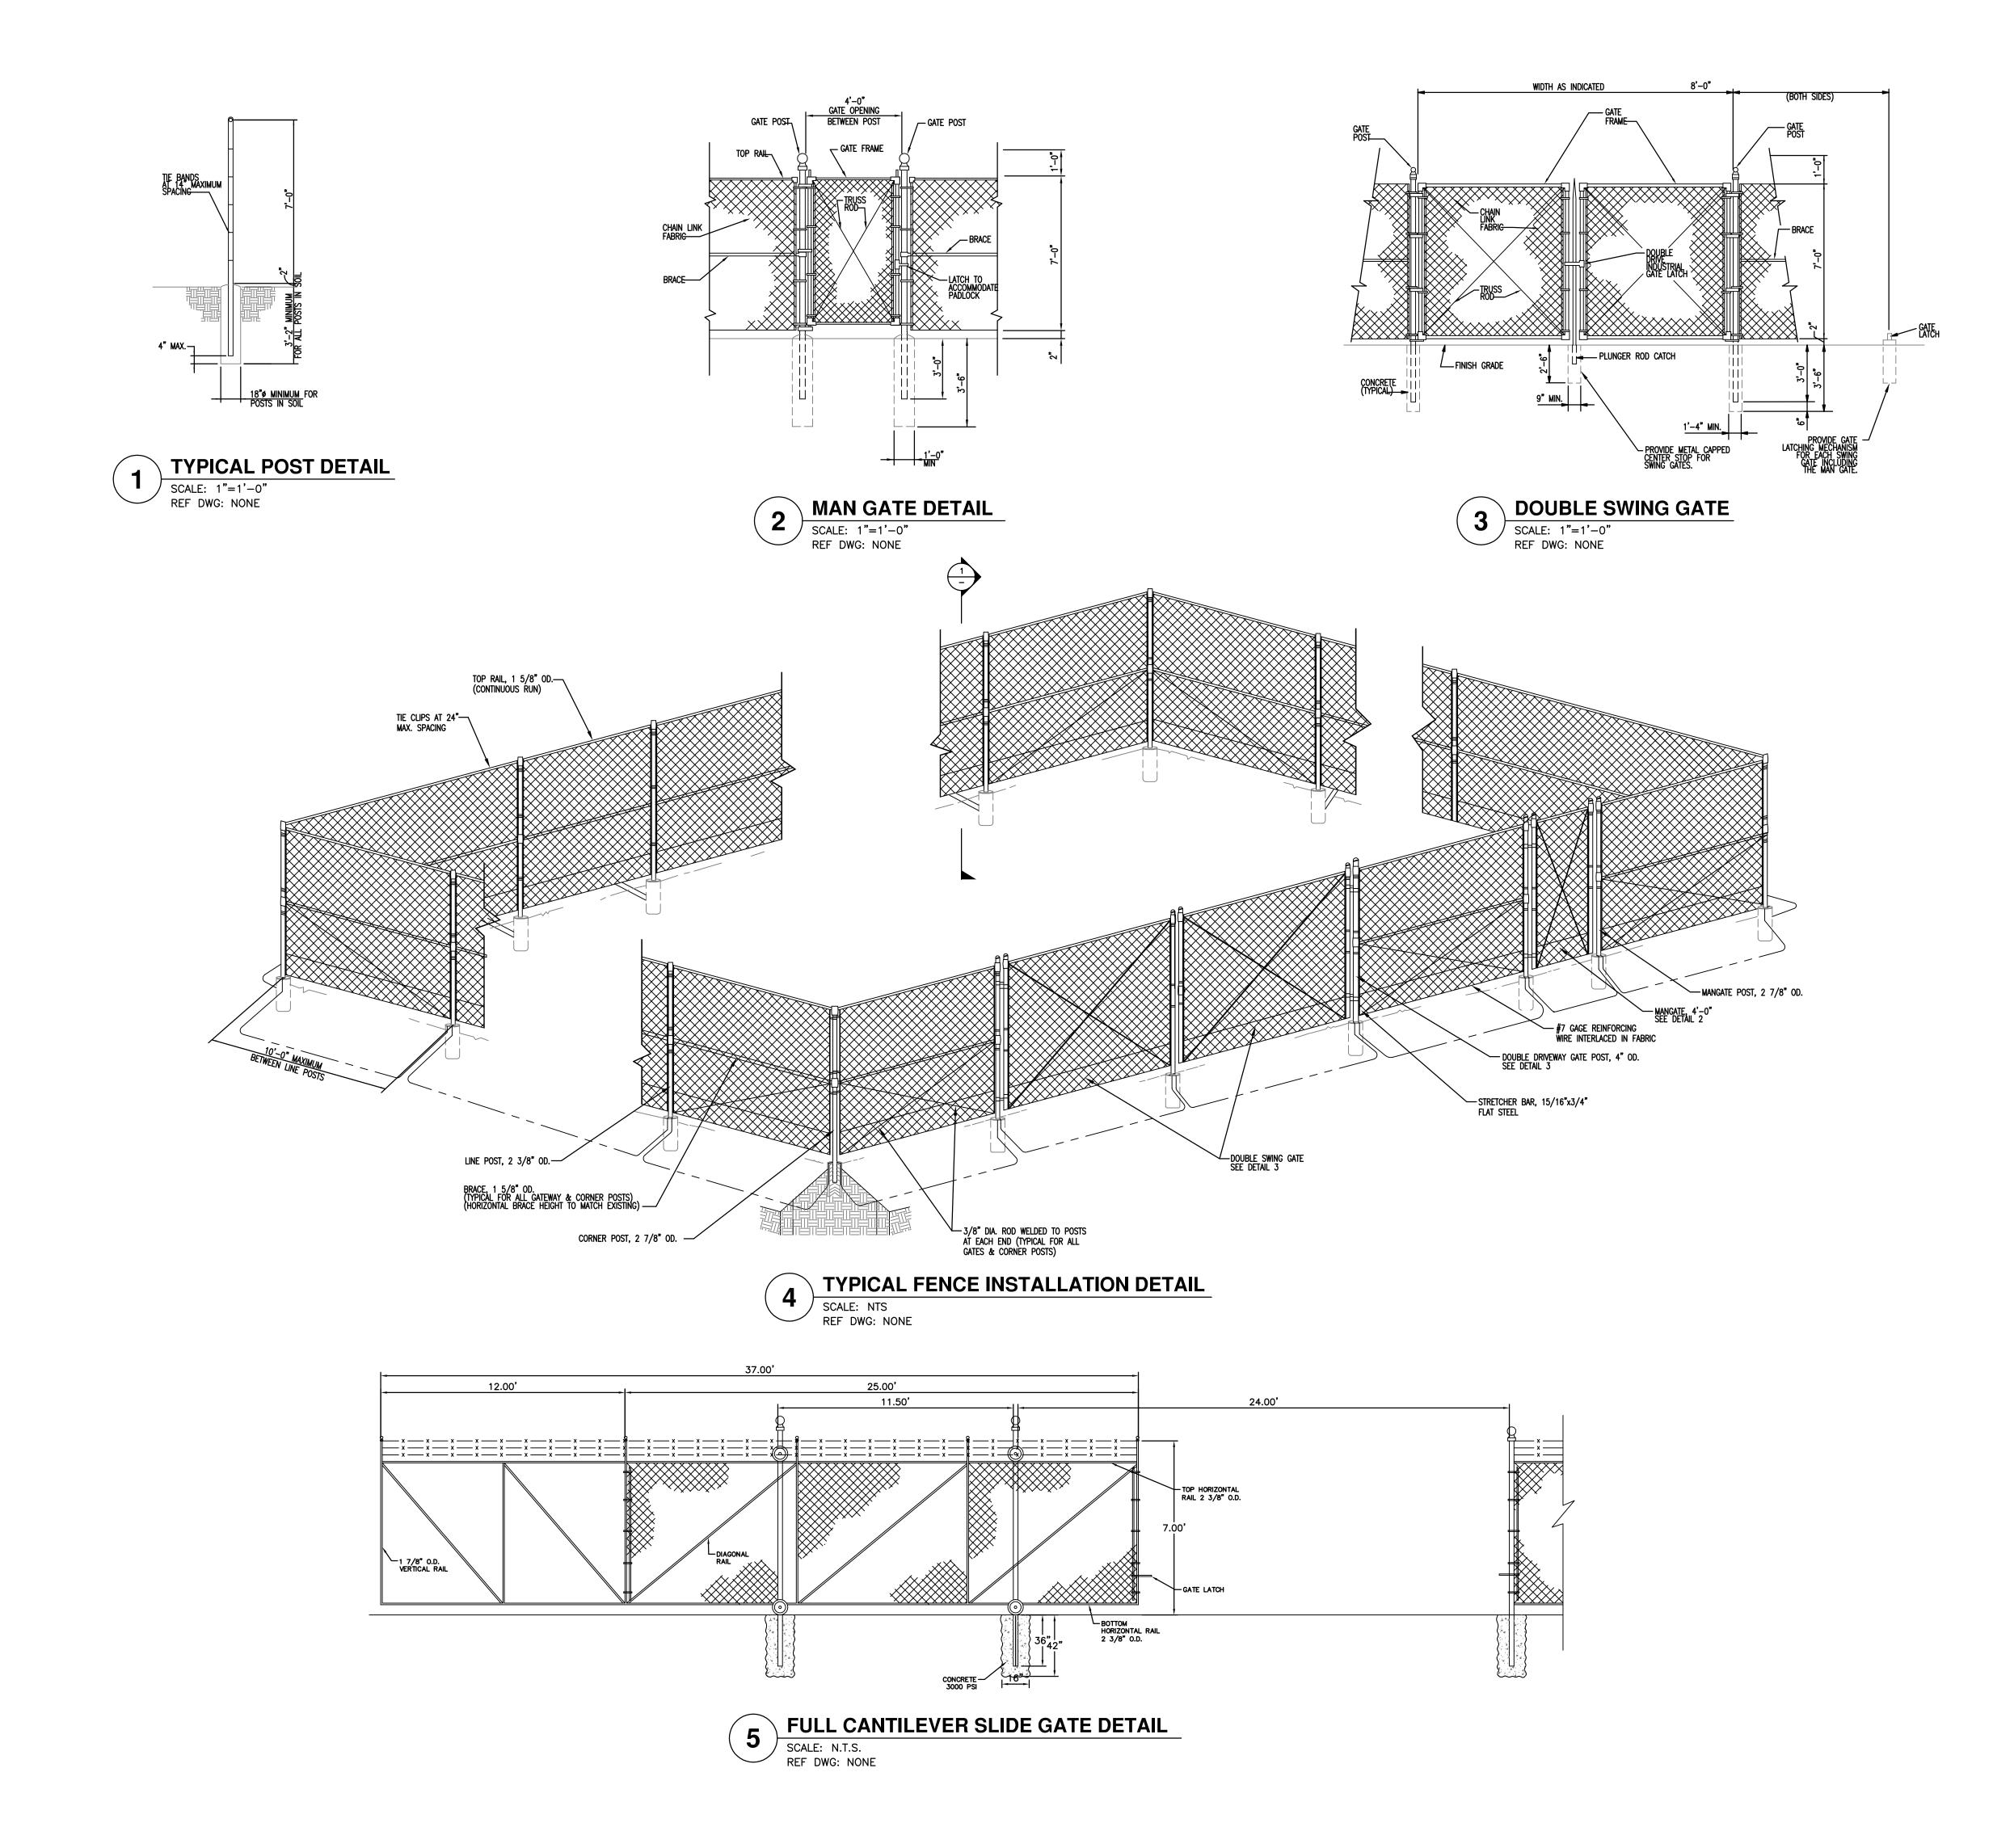
SPANISH FORK ARMORY PARKING IMPROVEMENTS Spanish Fork UT U.S.A.

Title

NORTH ACCESS APRON

Project No. 186302014	Scale 1" = 20'	
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ORIGINAL SHEET - ARCH D





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NOTE:

1- ALL NEW FENCING TO INCLUDE THREE (3)
STRAND BARBED SECURITY WIRE ALONG TOP



Revision		Ву	Appd.	YY.MM.
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File Name: 02014c-dt.dwg	MAC	GP	MAC	07/05/

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Permit-Seal

Client/Project

UTAH NATIONAL GUARD
SPANISH FORK ARMORY
PARKING IMPROVEMENTS


Spanish Fork UT U.S.A.


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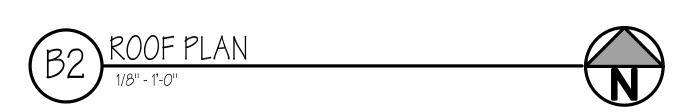
FENCE DETAIL SHEET


Project No. 186302014	Scale	
Drawing No.	Sheet	Revision
O-6	of	0

ORIGINAL SHEET - ARCH D



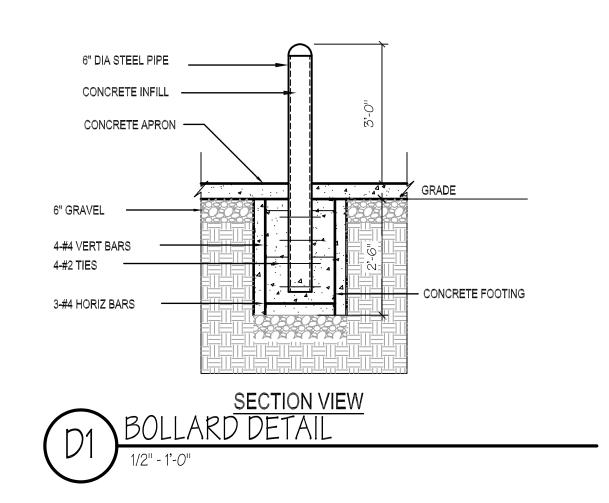

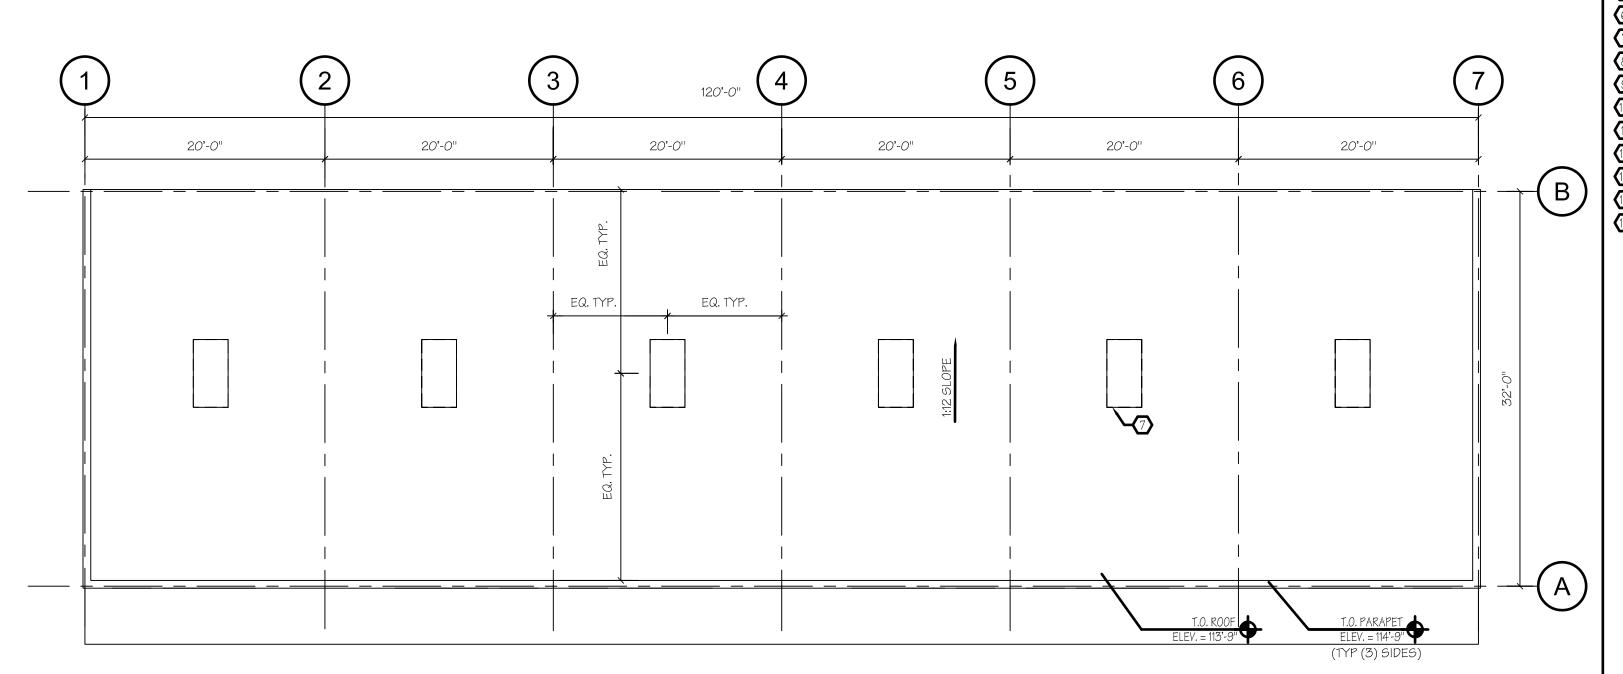

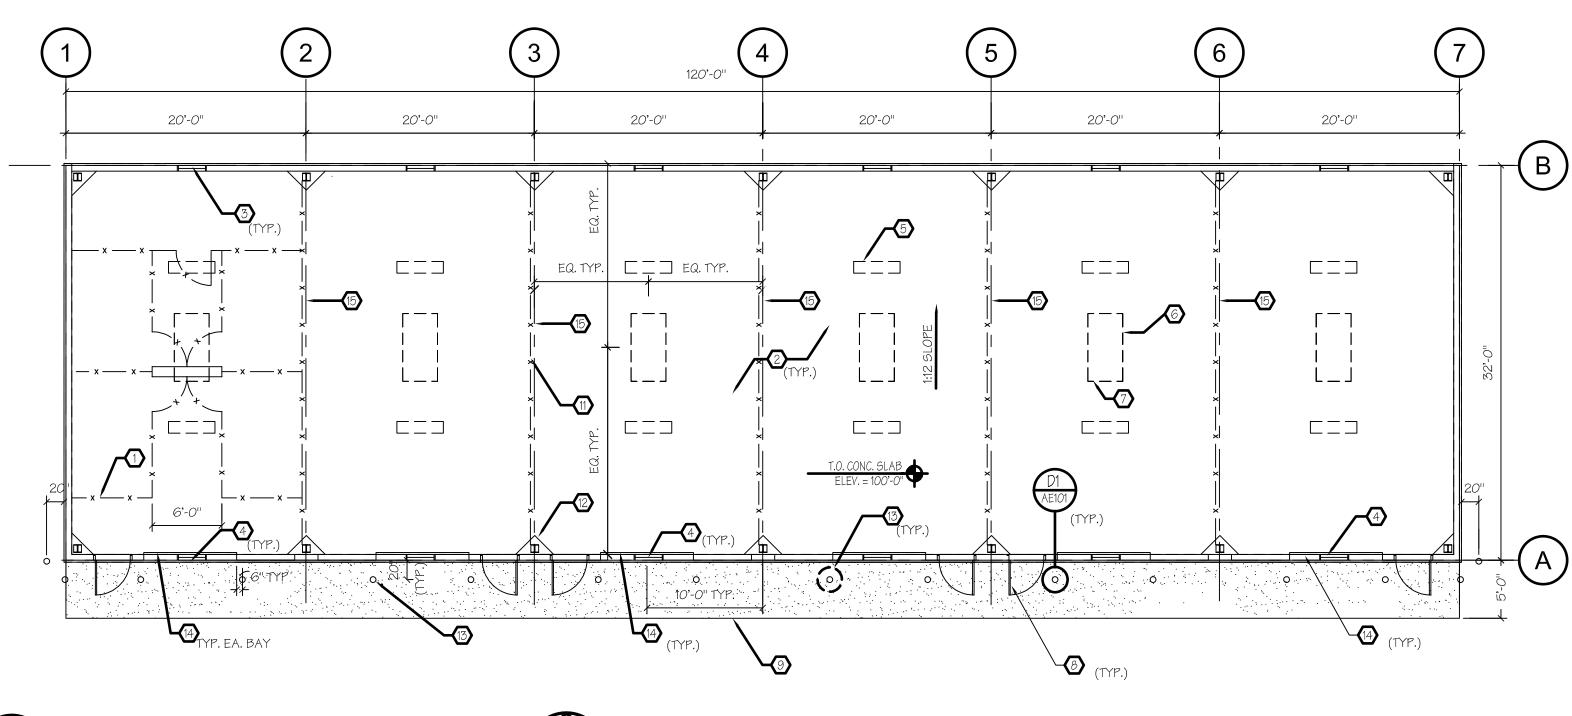

B1 MAIN FLOOR PLAN

1/8" - 1'-0"



ALTERNATE #1: PROVIDE FLOOR TO DECK WIRE MESH PARTITIONS, FRAMES, 3'-0"x 7'-0" GATES AND HARDWARE AS SHOWN FOR EACH OF SIX UNITS TO BE INSTALLED BY THE OWNER - PRICE PER BAY- IN ADDITION TO THE PARTITIONS BETWEEN EACH UNIT ALREADY IN CONTRACT. PLANS.

NEW CONCRETE SLAB, SEE SHEET 04.

30"x12" LOUVERED VENT W/ BUG SCREEN @ 12" A.F.F. - TYPICAL @ EACH BAY

30"x12" LOUVERED VENT W/ BUG SCREEN @ 12" OFF CLG - TPYICAL

LIGHT FIXTURE ABOVE, TYP. - SEE ELECTRICAL.

SKYLIGHT OR TRANSLUCENT PANEL ABOVE, TYP.

SKYLIGHT OR TRANSLUCENT PANEL BY BUILDING MANUFACTURER - 20 S.F. MIN.

36" HOLLOW METAL DOOR IN HOLLOW METAL FRAME.

© CONCRETE OVER GRAVEL BASE, SEE SHEET 04.

NOT USED

WIRE MESH PARTITION, FLOOR TO DECK.

CONCRETE PIERS & STEEL COLUMNS, TYP., SEE SHEET 04.

6" PIPE CONCRETE FILLED BOLLARDS - PAINT YELLOW.

96"x 120" METAL OVERHEAD DOOR.

CRACK CONTROL JOINT IN SLAB FROM PIER TO PIER @ EACH GRID LINE (TYP @ ALL GRIDS)

### GENERAL NOTES

1. NOTIFY ARCHITECT IF ANY EXISTING CONDITIONS VARY FROM THOSE SHOWN ON THE DRAWINGS.

2. REPAIR DAMAGE TO EXISTING ELEMENTS TO REMAIN RESULTING FROM DEMOLITION.

3. STRUCTURAL DESIGN TO BE PROVIDED BY BUILDING MANUFACTURER.

Revision

By Appd. YY.MM.D.

Issued

By Appd. YY.MM.D.

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HFS Architects

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SPANISH FORK ARMORY REMODEL

Spanish Fork UT U.S.A.

Title

Drawing No.

FLOOR PLAN, ROOF PLAN & DETAILS

Project No. Scale
DFCM#07263470

AE101 of

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Revision

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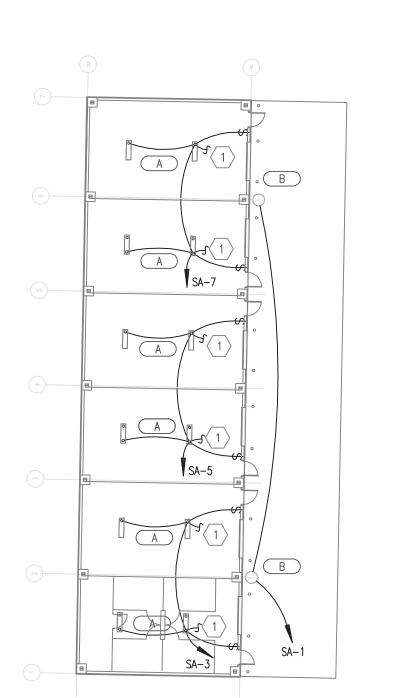
2863\active\18630201

ORIGINAL SHEET — ARCH D


2014/drawing\sheets\02014c-bidg site plan.dwg By: aacosta


FIXTURE SCHEDULE					
TYPE	DESCRIPTION	CATALOG NUMBER	VOLTS	LAMPS	
Α	2 LAMP T8 FLUORESCENT INDUSTRIAL FIXTURE	LITHONIA	120	(2) F032/835	
	WITH COLD WEATHER ELECTRONIC BALLAST	AFST 232 120 CW			
		METALUX			
		ECIM 232 120V CW			
		LIGHTOLIER			
		TF4S232 120 SO CW			
		DAY-BRITE			
		1F 232-PPS-120-LT			
		COLUMBIA			
		KL4-232-PRST-EB8Z 120			
В	250 WATT METAL HALIDE WALL PACK WITH	LITHONIA	120	(1) 250W MH	
	PHOTOCELL	TWH 250M 120 PE			
		LUMARK			
		MH WL 250 120V PE			
		GENERAL ELECTRIC			
		WM4T25M0/PEK-120			
		DAY-BRITE			
		WLR 250M 12-WLS-PEC12			
		HUBBELL			
		PGM-250H-128-1-PBT-1			

LIGHT FIXTURE ABBREVIATION SCHEDULE			LIGHT FIXTURE GENERAL NOTES	
A.F. WAL CCE SCB CFB SFB MOD	NOTE: NOT ALL ABBREVIATIONS WILL NECESSARILY BE USED.  F. ABOVE FINISHED FLOOR  L@CLG WALL MOUNT AT CORNER OF WALL AND CEILING  CUSTOM PAINTED COLOR AS SELECTED BY THE ARCHITECT  A STANDARD PAINTED COLOR AS SELECTED BY THE ARCHITECT  CUSTOM FINISH AS SELECTED BY THE ARCHITECT  A STANDARD FINISH AS SELECTED BY THE ARCHITECT  MODIFY STANDARD LIGHT FIXTURE AS INDICATED	2. 3. 4. 5.	REFER TO THE ARCHITECTURAL REFLECTED CEILING PLANS FOR LOCATIONS OF LIGHT FIXTURES. BRING ALL DISCREPANCIES OF LOCATIONS AND QUANTITIES TO THE ATTENTION OF THE ARCHITECT AND ELECTRICAL ENGINEER PRIOR TO BIDDING.  REFER TO ARCHITECTURAL ELEVATIONS FOR MOUNTING HEIGHTS AND LOCATIONS OF LIGHT FIXTURES. BRING ALL DISCREPANCIES TO THE ATTENTION OF THE ARCHITECT PRIOR TO BIDDING.  REFER TO THE SPECIFICATIONS FOR OTHER LIGHT FIXTURE, FUSING, BALLAST, AND LAMP REQUIREMENTS AND ACCEPTABLE MANUFACTURERS.  REFER TO ARCHITECTURAL DRAWINGS AND SPECIFICATIONS FOR LOUVER REQUIREMENTS AS REQUIRED.  CONFIRM AVAILABLE MOUNTING DEPTHS OF ALL LIGHT FIXTURES AND COMPARE WITH DEPTHS SHOWN ON SHOP DRAWINGS. BRING ALL POTENTIAL CONFLICT AREAS TO THE ATTENTION OF THE ARCHITECT AND ELECTRICAL ENGINEER PRIOR TO RELEASE.	
	BI	וטטו	NG REQUIREMENTS	
1.	BID ONLY PRODUCTS THAT ARE SPECIFIED OR APPROVED BY ADDENDUM	Л.		
2.	PACKAGING OF LIGHT FIXTURES WITH OTHER SYSTEMS IS NOT ALLOWED.	•		
3.	WHEN ONLY ONE PRODUCT IS APPROVED FOR BIDDING, THE PRICE FOR DISTRIBUTORS AND/OR CONTRACTORS.	R TH	AT ITEM SHALL BE BROKEN OUT SEPARATELY WHEN SUBMITTING PRICING TO VARIOUS	
4.	WHEN A CONTRADICTION EXISTS BETWEEN A SPECIFIC MODEL NUMBER	AND	THE DESCRIPTION, THE DESCRIPTION SHALL GOVERN.	
	PRIOR	AP	PROVAL REQUIREMENTS	
1.	1. PRIOR APPROVAL IS REQUIRED BEFORE BIDDING THIS PROJECT.			
2.	2. PRIOR APPROVALS SHALL BE SUBMITTED TO THE ELECTRICAL ENGINEER'S OFFICE AT LEAST (8) EIGHT WORKING DAYS BEFORE THE BID. PRIOR APPROVALS RECEIVED AFTER THIS TIME PERIOD SHALL BE REJECTED.			
3.	3. PRIOR APPROVALS SHALL BE SIGNED BY A PRINCIPAL OF THE SUBMITTING ORGANIZATION STATING THAT THEY HAVE PREPARED AND/OR REVIEWED THE SUBMITTAL AND THAT THE PRODUCTS PROPOSED ARE EQUIVALENT TO THOSE SPECIFIED. ANY EXCEPTIONS SHALL BE SO NOTED.			
4.	4. ITEMS THAT ARE SUBMITTED AND HAVE BEEN APPROVED WILL BE LISTED IN THE ADDENDUM(S). VERBAL APPROVAL WILL NOT BE GIVEN ON ANY ITEM.			
5.	5. IT IS <u>NOT</u> THE RESPONSIBILITY OF THE ELECTRICAL ENGINEER TO NOTIFY THE SUBMITTING PARTY OF ERRORS IN THE SUBMITTAL. NOTIFICATION OF ERRORS BY THE ELECTRICAL ENGINEER PRIOR TO ISSUANCE OF THE ADDENDUM(S) MAY NOT BE GIVEN.			
6.	6. PRIOR APPROVALS SHALL CONSIST OF TWO SETS OF CUT SHEETS DESCRIBING THE PRODUCTS BEING SUBMITTED AS EQUIVALENTS. FAXES ARE <u>NOT</u> ACCEPTABLE. ALL SPECIFICATION INFORMATION SHALL BE CLEARLY MARKED, WITH NON—APPLICABLE INFORMATION CROSSED OUT. COMPLETE PHOTOMETRIC DATA SHALL BE PROVIDED. PRODUCTS WITHOUT PHOTOMETRIC DATA WILL <u>NOT BE</u> APPROVED.			
7.	SUPPLY POINT-BY-POINTS AS REQUIRED BY THE ELECTRICAL ENGINEER	R AN	D/OR LIGHTING DESIGNER.	
8.	SAMPLE FIXTURES MUST BE SUPPLIED WITH A CORD, PLUG AND 120V	BALI	LAST.	
	LIGHTING SHOP DRAWING REQUIREMENTS			
1.	1. REFER TO SPECIFICATIONS 16001, 16510 & 16551.			
2.	2. MUST INCLUDE BALLAST AND LAMP CUT SHEETS.			
3.	3. LINEAR LIGHTING MUST INCLUDE DETAILED DRAWINGS WITH SUPPORT DETAIL?			
4.	4.			
5.	5.			
6.	APPROVED. , REVIEWED OR			
7.	. PROVIDE A LIST OF SPARE PARTS, EQUIPMENT & LAMPS.			



LIGHTING PLAN

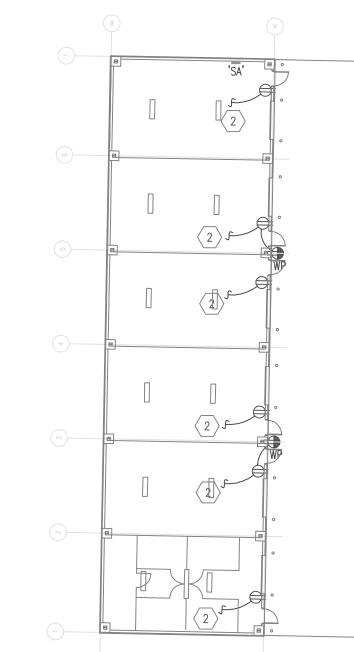

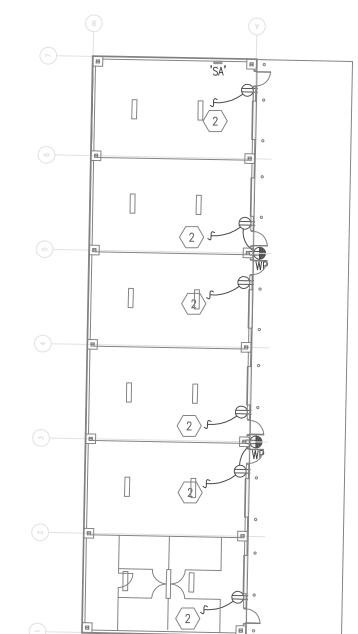



PLAN NORTH

## SHEET KEYNOTES

GENERAL NOTES

1. CONSULT ARCHITECTURAL REFLECTED CEILING PLANS FOR EXACT LOCATION OF ALL LIGHTING FIXTURES.

2. VERIFY ALL EQUIPMENT DIMENSIONS AND LOCATIONS BEFORE BEGINNING ROUGH IN. CONSULT ALL APPLICABLE CONTRACT DRAWINGS AND SHOP DRAWINGS TO INSURE NEC CODE

3. CONTRACTOR SHALL VERIFY ALL ELECTRICAL LOADS (VOLTAGE, PHASE, CONNECTION

4. SEE SECTION 16510 OF THE SPECIFICATION REQUIRED COORDINATION MEETINGS WITH MECHANICAL AND CEILING CONTRACTORS.

6. SEE SPECIFICATION FOR ENERGY SAVING LAMP AND BALLAST REQUIREMENTS.

7. FINISHES OF ALL LIGHT FIXTURES SHALL BE AS SELECTED BY ARCHITECT.

5. SEE APPLICABLE SHOP DRAWINGS FOR ROUGH IN LOCATION OF ALL EQUIPMENT, WIRING

8. THE ELECTRICAL CONTRACTOR SHALL NOTIFY AND COOPERATE WITH THE MECHANICAL CONTRACTOR SUCH THAT NO PIPING, DUCTS, OR EQUIPMENT FOREIGN TO THE OPERATION OF THE ELECTRICAL EQUIPMENT SHALL BE PERMITTED TO BE INSTALLED IN, ENTER OR PASS

THRU ELECTRICAL ROOMS OR SPACES, OR ABOVE OR BELOW ELECTRICAL EQUIPMENT IN

9. ELECTRICAL BOXES SHALL NOT BE LOCATED IN MASONRY COLUMNS IN BRICK WALLS OR IN GROUTED CELLS ADJACENT TO OPENINGS. COORDINATE LOCATION OF BOXES WITH MASONRY

10. ALL PENETRATIONS OF FIRE RATED FLOORS, WALLS, AND CEILINGS SHALL BE SEALED WITH

11. CIRCUITS EXTENDING OVER 70' FOR 120 VOLT AND 165' FOR 277 VOLT 20 AMP CIRCUITS

APPROVED MATERIAL TO MAINTAIN FIRE RATING OF SURFACE PENETRATED.

DEVICES, ETC. WHERE APPLICABLE MOUNT ALL WIRING DEVICES ABOVE BACK SPLASH EXCEPT

CLEARANCES REQUIRED AROUND ALL ELECTRICAL EQUIPMENT.

MECHANICAL SHOP DRAWINGS BEFORE BEGINNING ROUGH IN.

THOSE SERVING UNDER COUNTER EQUIPMENT.

SHALL BE RUN WITH MINIMUM #10 CONDUCTORS.

- (1) CIRCUIT TO RECEPTACLE THIS BAY.
- $\langle$  2  $\rangle$  CIRCUIT TO LIGHT FIXTURE THIS BAY.

12. ALL CONDUIT SHALL BE 3/4" MINIMUM.

### ELECTRICAL SYMBOL SCHEDULE

1. SEE FIXTURE SCHEDULE FOR TYPE, MOUNTING AND WATTAGE.
2. HEIGHT MEASURED TO CENTER LINE OF THE BOX FROM THE FINISH FLOOR.
3. REFER TO DRAWINGS FOR DIRECTIONAL ARROWS.
4. SUBSCRIPT KEYS SWITCH TO FIXTURES CONTROLLED.
5. NEMA TYPE 'ND' NON-FUSED UNLESS NOTED 'F' (FUSED). USE 'HD' 480 V.
6. HEIGHT TO BE THE LOWER OF EITHER 80" A.F.F. OR 6" BELOW CEILING.
7. PROVIDE H.O.A. AND S.S. PUSHBUTTONS AS REQUIRED.
8. DOUBLE ARROWS DENOTE A DOUBLE FACE UNIT.
9. COORDINATE WITH MILLWORK SHOP DRAWINGS AND ELEVATIONS FOR HEIGHT.

10. SUBSCRIPT DENOTES NEMA CONFIGURATION.

11. HEIGHT MEASURED TO BOTTOM OF THE BOX FROM FINISH FLOOR. STANDARD MOUNTING HEIGHT UNLESS OTHERWISE NOTED ON PLANS

STANDARD I	MOUNTING HEIGHT UNLESS OTHERWISE NOTED ON P	LANS	
SYMBOL	DESCRIPTION	MOUNTING HEIGHT	NOTES
	ONE CIRCUIT, TWO WIRE HOME RUN TO PANEL		
-	2 CIRCUIT, 3 WIRE, COMMON NEUTRAL HOME RUN		
#	3 CIRCUIT, 4 WIRE, COMMON NEUTRAL HOME RUN		
	CONDUIT RUN CONCEALED IN WALL OR CEILING		
	CONDUIT RUN CONCEALED IN FLOOR OR GROUND		
	CONDUIT UP		
-	CONDUIT DOWN		
	CONDUIT STUB LOCATION	CAP CONDUIT	
	CABLE TRAY	AS NOTED	
$\overline{}$	CEILING LIGHT FIXTURE	CEILING	1.
$\overline{\mathbb{C}}$	WALL LIGHT FIXTURE	AS NOTED	1.
	RECESSED DOWNLIGHT FIXTURE	CEILING	1.
	FLUORESCENT LIGHT FIXTURE	AS NOTED	1
	FLUORESCENT EGRESS LIGHT FIXTURE	AS NOTED	UNSWITCHED
	AREA LIGHT POLE AND FIXTURE	CONCRETE	SEE DIAGRAM
$\bigcirc$	FLOOD OR TRACK FIXTURE	AS NOTED	SEE DIAGRAM
			1 7 0
$\bigcirc$	CEILING MOUNTED EXIT LIGHT	CEILING	1.3.8.
-	WALL MOUNTED EXIT LIGHT	AS NOTED	1.3.8.
\$	SINGLE POLE SWITCH	+4'-0"	2.
\$° \$3	SINGLE POLE SWITCH	+4'-0"	4. 2.
Ψ	THREE-WAY SWITCH	+4'-0"	2.
\$ <sup>4</sup>	FOUR-WAY SWITCH	+4'-0"	2.
\$K	KEY OPERATED SWITCH	+4'-0"	2.
\$P	SWITCH WITH PILOT LIGHT	+4'-0"	2.
\$D	VARIABLE INTENSITY SWITCH	+4'-0"	2.
\$ <sup>TM</sup>	TIMER SWITCH	+4'-0"	2.
PP	POWER PACK	CEILING +16" OR	SEE DIAGRAM, SPEC.
<del>-</del>	DUPLEX RECEPTACLE UPPER OUTLET SWITCH CONTROLLED	AS NOTED +16" OR	9. 11.
<del></del>	DUPLEX RECEPTACLE	AS NOTED	9. 11.
<b>₽</b> A	DUPLEX RECEPTACLE	.04" 00	9.
₩P	WEATHERPROOF RECEPTACLE	+24" OR AS NOTED	2. 9.
	GROUND FAULT INTERRUPTER DUPLEX RECEPTACLE	+16" OR AS NOTED	9. 11.
#	FOURPLEX RECEPTACLE	+16" OR AS NOTED	9. 11.
	SPECIAL PURPOSE OUTLET	+16" OR AS NOTED	10. WITH CAP. 11.
	TELEPHONE/DATA OUTLET	+16" OR AS NOTED	9. 11.
	TELEPHONE OUTLET	FLOOR	
J	JUNCTION BOX ('F' IN FLOOR)	AS NOTED	
/ /	MOTOR OUTLET	TO SUIT EQUIP.	
P	PHOTO-ELECTRIC CONTROL	AS NOTED	TORK 2000A
TC	TIME CLOCK	+5'-0"	2.
	PUSHBUTTON	+4'-0"	2.
	NON-FUSED DISCONNECT SWITCH	+5'-0"	5.
F	FUSED DISCONNECT SWITCH	+5'-0"	5.
\$ <sup>T</sup>	MANUAL STARTER THERMAL OVERLOAD SWITCH WITH PILOT LIGHT	+4'-0"	2.
	MAGNETIC STARTER	+5'-0"	7.
	MAGNETIC STARTER / DISCONNECT COMBINATION	+5'-0"	
VFD	VARIABLE FREQUENCY DRIVE	+6'-6"	
	PANEL BOARD	TOP AT +6'-0"	
842	ARCHITECTURAL ROOM NUMBER	15 5	
A	LIGHT FIXTURE (LETTER DESIGNATES TYPE)		
(EQ) (34)	EQUIPMENT NUMBER		
<u> </u>			

### INDEX OF ELECTRICAL DRAWINGS

EG001 SYMBOLS, SCHEDULES NOTE, & FLOOR PLANS

ES101 ELECTRICAL SITE PLAN EX101 ONE LINE DIAGRAM & PANELBOARD SCHEDULES

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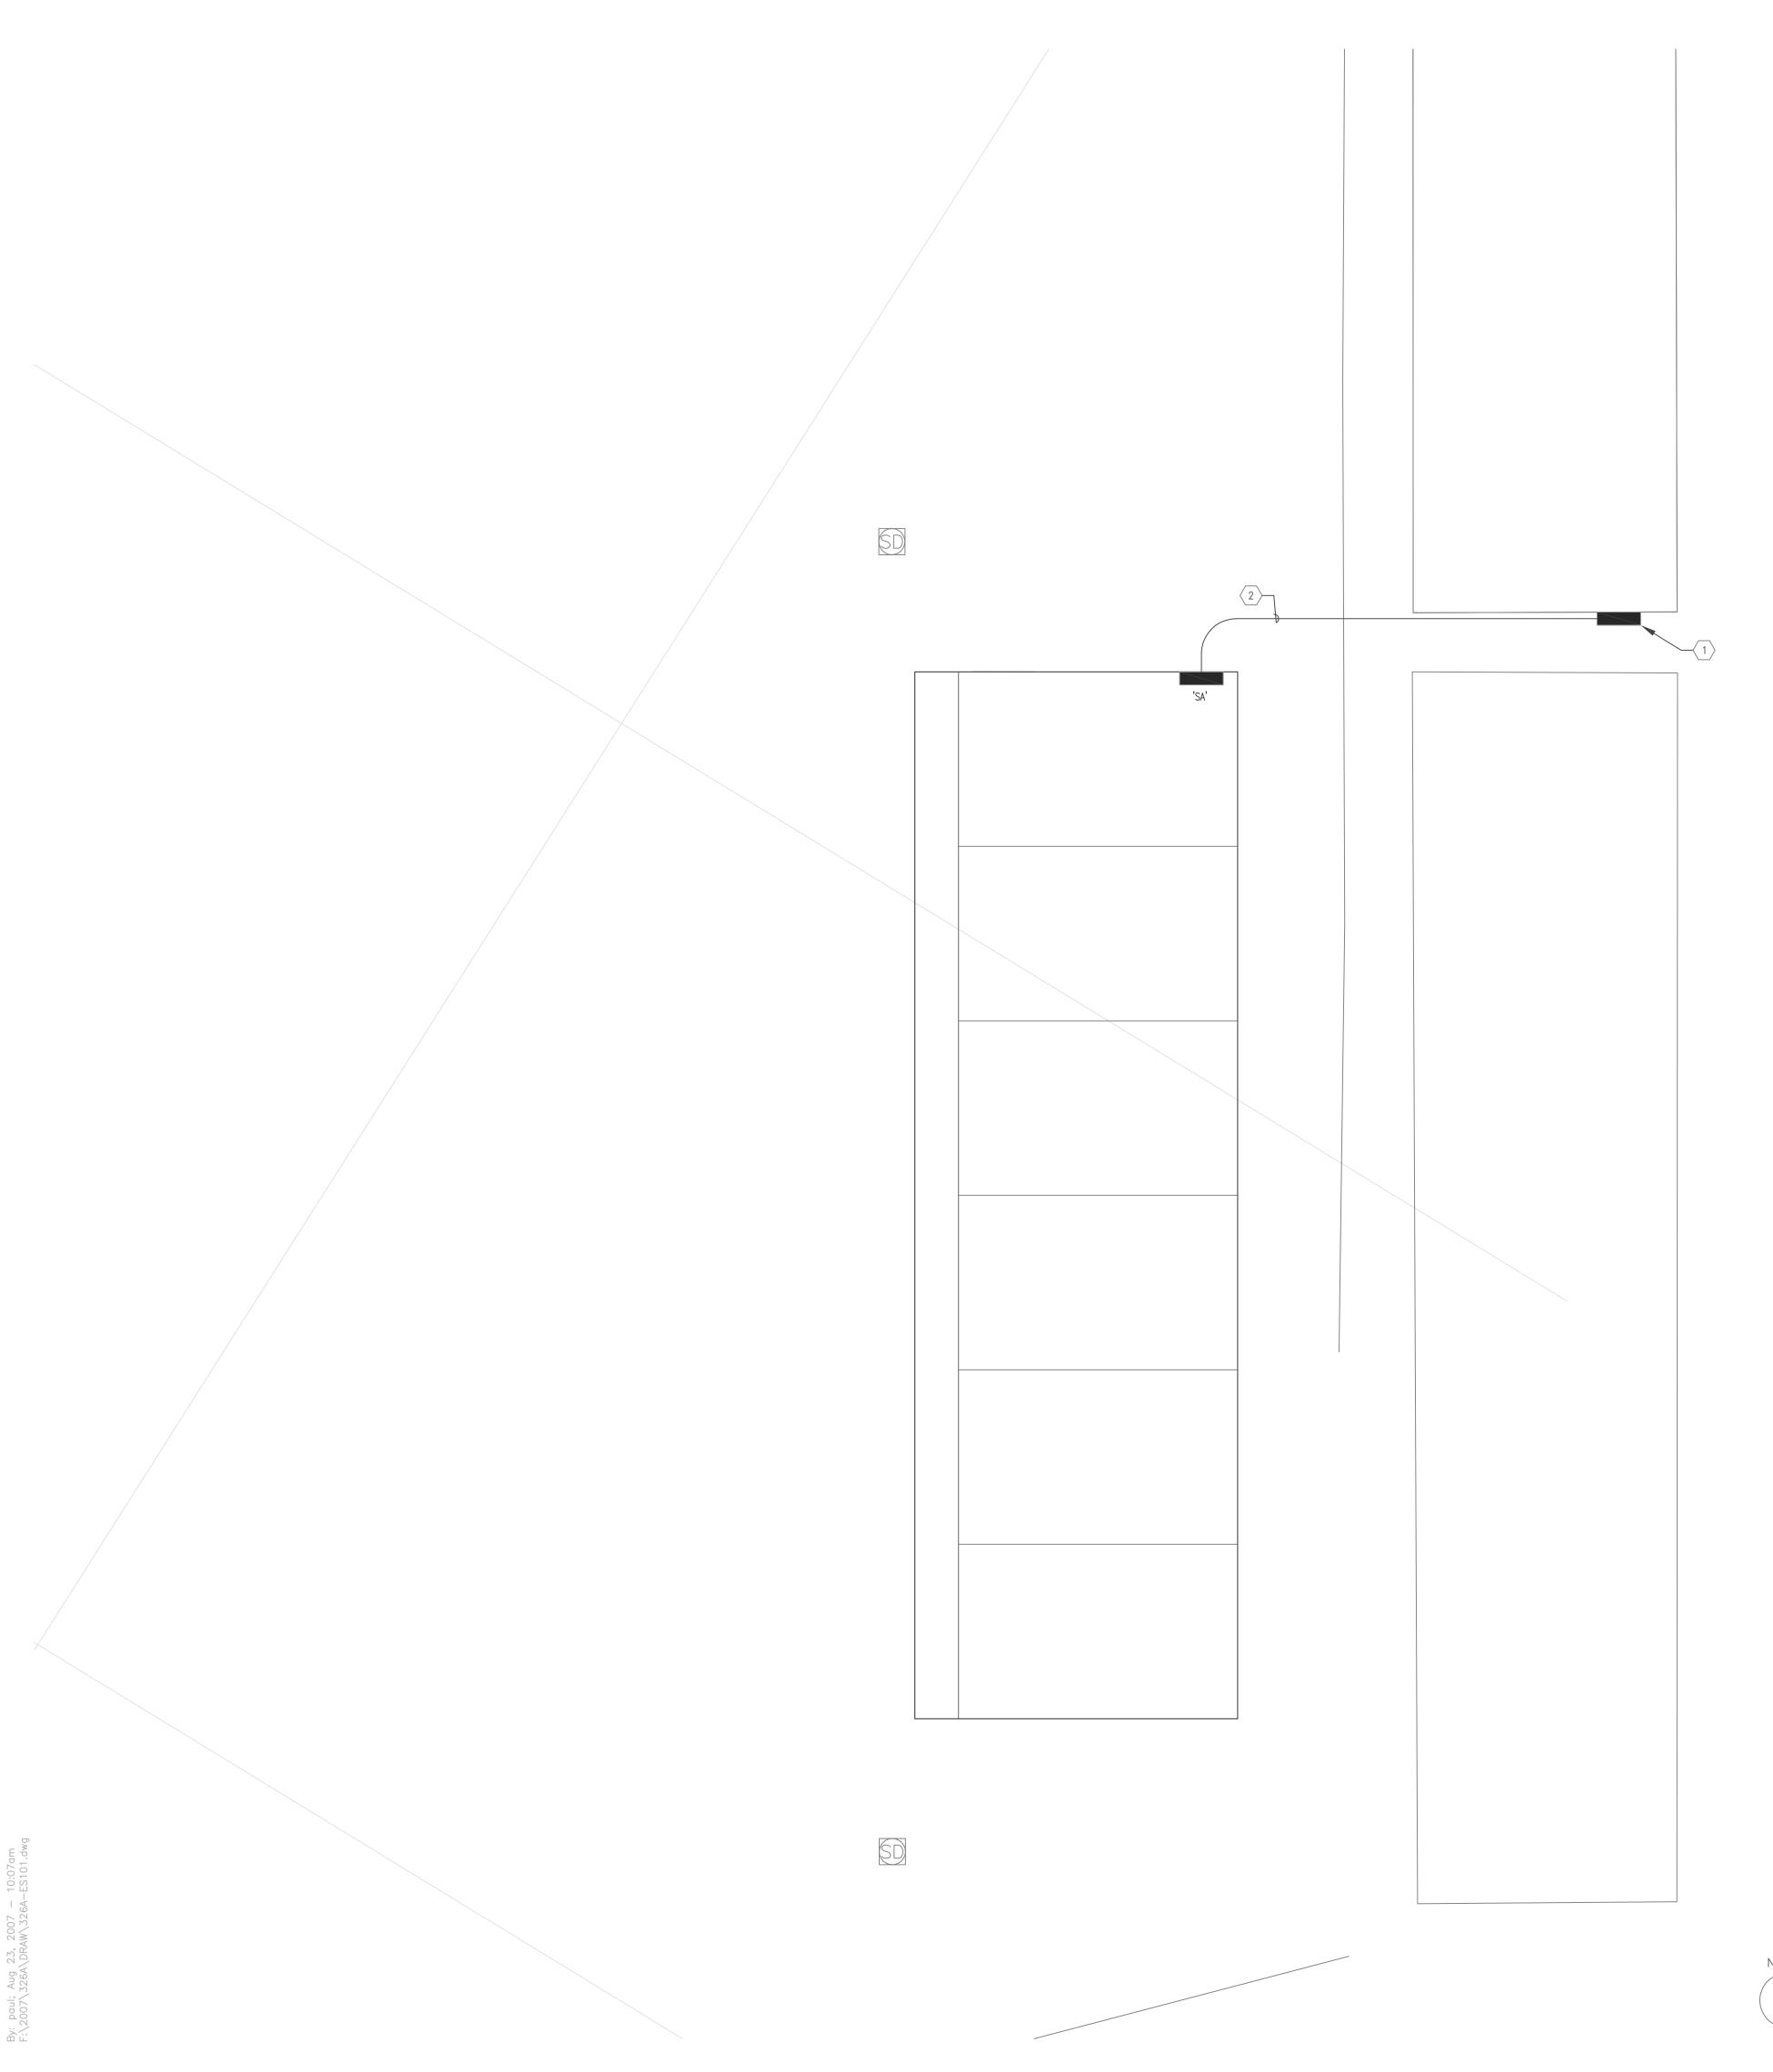
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UTAH NATIONAL GUARD SPANISH FORK ARMORY PARKING IMPROVEMENTS Spanish Fork UT U.S.A.

SYMBOLS, SCHEDULES AND NOTES


Project No. 07326A	Scale 1" = 20'	
Drawing No.	Sheet	Revision
EG001	of	0

PLAN NORTH





- 1) EXISTING PANEL. PROVIDE NEW BREAKER TO FEED NEW PANEL. SEE ONE-LINE DIAGRAM SHEET EX101.
- UNDERGROUND POWER FEEDER (24" BELOW GRADE MINIMUM). CUT AND PATCH EXISTING PAVEMENT. DETERMINE LOCATION OF EXISTING BURIED UTILITIES AND LINES THAT WILL BE CROSSED BY FEEDER, ADJUST BURIAL DEPTH TO AVOID CONFLICTS. PROVIDE CONCRETE ENCASEMENT (SEE DIAGRAM P009/EX101).

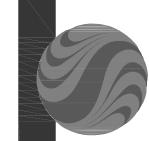

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Legend

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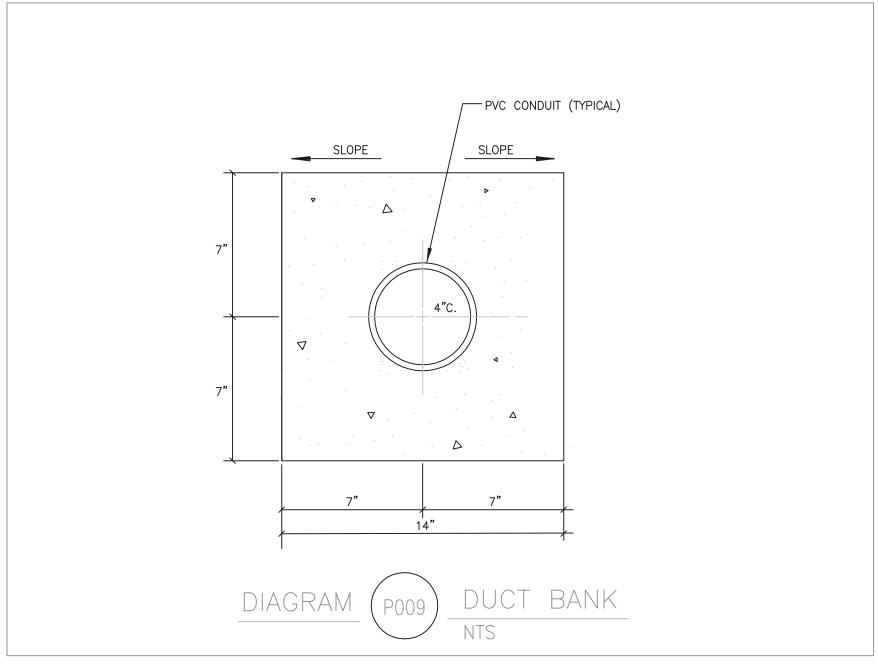
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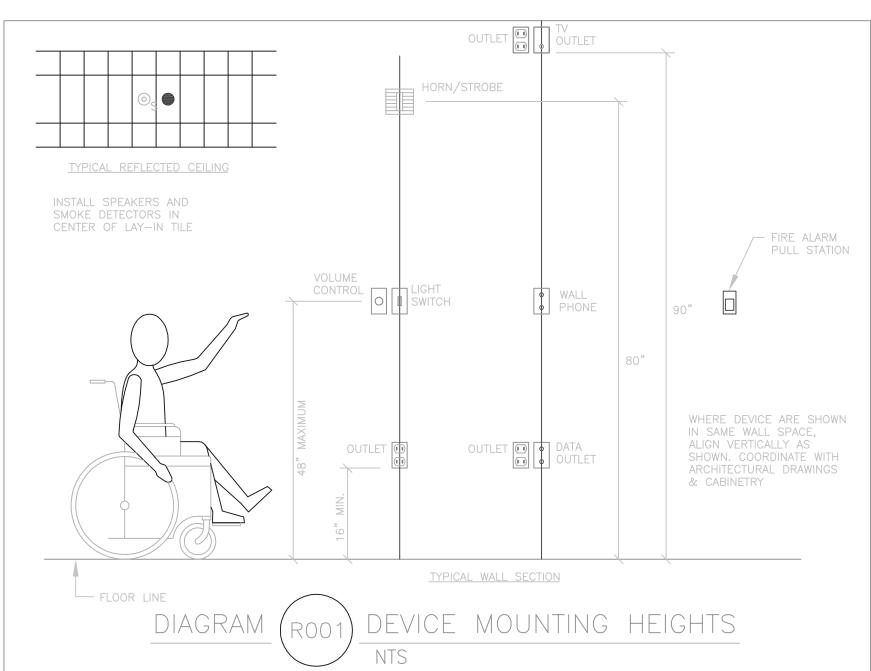
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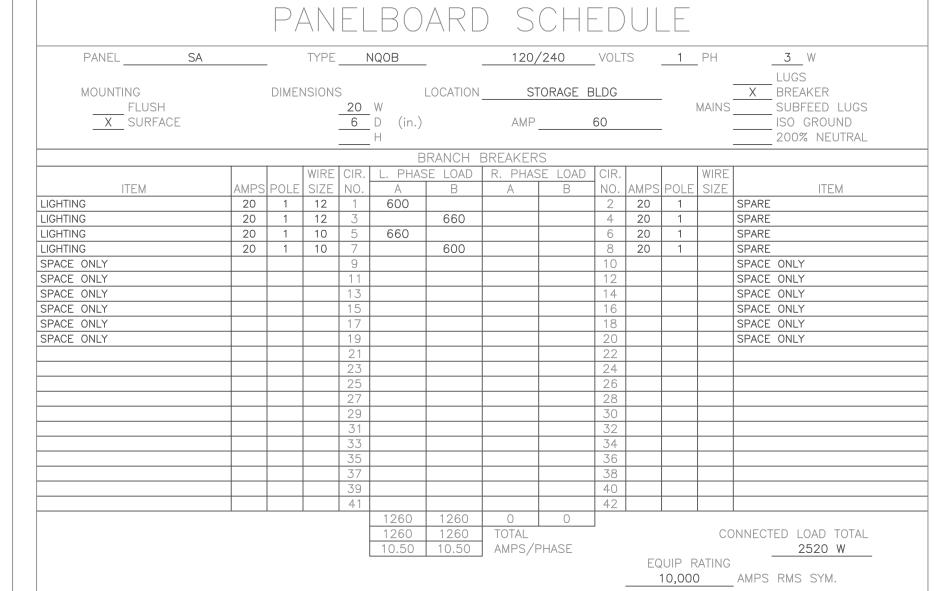
ELECTRICAL SITE PLAN

Project No. 07326A	Scale 1" = 10'	
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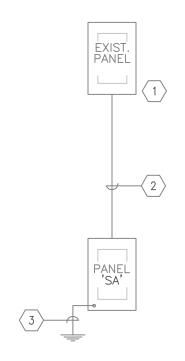




### SHEET KEYNOTES

- 1 PROVIDE NEW 60 AMP, 2 POLE, BREAKER IN EXISTING PANEL TO FEED NEW PANEL 'SA'.

  2 PROVIDE (3) #2 THWN CU, (1) #6 THWN CU GND. IN A 1-1/2" CONDUIT.
- PROVIDE (1) #8 THWN CU GROUND CONDUCTOR TO TWO GROUND RODS DRIVEN EXTERIOR TO BUILDING, TIE TO BUILDING STRUCTURAL STEEL AND TO UFER GROUND IN FOOTING PER SPECIFICATION.







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Consultants

Legend

Notes



Revision		Ву	Appd.	YY.MM.
1 PRELIMINARY SUBMITTAL		AEA	GP	07/10,
Issued		Ву	Appd.	YY.MM.
File Name: 02014c—building site plan.dwg	AEA	GP	AEA	07/05,
	Dwn.	Chkd.	Dsgn.	YY.MM.
Permit-Seal				

Client/Project

UTAH NATIONAL GUARD
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PARKING IMPROVEMENTS
Spanish Fork UT U.S.A.

Title

ONE-LINE DIAGRAM AND PANELBOARD SCHEDULES

Project No. 07326A	Scale NTS	
Prawing No.	Sheet	Revision
EX101	of	0